Northville DDA Economic Development Committee



Thursday, May 26, 2020 – 3:30 pm

Via Zoom Meeting

The meeting will be held via video conference in compliance with Executive Order 2020-75, issued by Michigan Governor Whitmer, temporary authorization of remote participation in public meetings and hearings. Members of the public body and members of the public participating electronically will be considered present at the meeting and may participate as if physically present at the meeting.

The following is a link to attend the meeting scheduled for Thursday, May 26, 2020 at 3:30 pm:

https://us02web.zoom.us/j/84080388112

Meeting ID: 840 8038 8112

Dial by your location

+1 312 626 6799 US (Chicago), Meeting ID: 840 8038 8112

Log in Instructions, Meeting Rules and Tips are available on the City's website at this link: https://www.ci.northville.mi.us/cms/One.aspx?portalld=11895963&pageId=13505469#pc OR from the main Home page, click on the Government tab, then Agendas and Minutes, scroll to the Downtown Development Authority section of the webpage, and scroll down to the link for this meeting. "Zoom Webinar User Guide for City of Northville PCity of Northville is inviting you to a scheduled Zoom meeting."

Meeting Agenda

Public Comment

- 1. 150 156 N. Center Street Presentation by Robert Miller (Attachment 1)
- 2. MEDC Programs Michelle Aniol (Attachment 2)
- 3. Master Plan Update Carol Maise
- 4. Next Meeting June 25, 2020

P.C. REVIEW

ISSUE DATE

NOT FOR CONSTRUCTION

PRESLEY ARCHITECTURE

SUITE 2C NORTHVILLE,MICHIGAN PHONE 248.349.2708

PROJECT NEW BUILDING AND **BUILDING ADDITION**

Northville, MI 481467

PROJECT ADDRESS

150 /156 North Center Street

150 / 156 North Center Street Northville, MI 48167

PROJECT NUMBER

SHEET NAME **COVER SHEET**

SHEET NUMBER

150-156 NORTH CENTER STREET NEW BUILDING AND BUILDING ADDITION

NORTHVILLE, MICHIGAN

C1.0

S-2 S-3 S-4 S-5

SITE UTILITY PLAN

Owner| 156 N Center LLC 42300 West Nine Mile Road Novi, Michigan 48375 248 | 349 | 1009

Architect M Archictects 114 Rayson Street Suite 2C Northville, Michigan 48167 248 | 349 | 2708

Civil Engineer | Zeimet Wozniak & Associates 55800 Grand River Suite 100 New Hudson, Michigan 48165 248 | 437 | 5099

PROJECT INFORMATION - EXISTING

PROJECT INFORMATION - PROPOSED

CBD COMMERCIAL / RESIDENTIAL | 150 N CENTER: 1,588 sqft (.036 ACRES) | 150 N CENTER: 94.7%

PROJECT TOTAL: 5,383 sqft (.123 ACRES)

COMMERCIAL / RESIDENTIAL | PROJECT TOTAL: 5,383 sqft (.123 ACRES) | 150-156 N CENTER: 95.5%

156 N CENTER: 3,795 sqft (.087 ACRES) **156 N CENTER**: 55.4%

ZONING EXISTING LAND USE

ZONING PROPOSED LAND USE

BELOW

REQUIRED

PARKING CALCULATIONS - EXISTING						
USE	PARKING REQUIREMENTS	USE AREA	CALCULATION	TOTAL SPACES REQUIRED	EXISTING PARKING SPACES	
RESTAURANT	1 space / 150 sqft	150 N CENTER (TUSCAN CAFE): 1,505 sqft 156 N CENTER : 0	1,505 / 150 = 10 SPACES	21.5 SPACES	156 N CENTER: 4.0 SPACES ON SITE (THESE WILL BE REMOVED)	
RESIDENTIAL	1 space / Bedroom	150 N CENTER: (3) TOTAL BEDROOMS 156 N CENTER: 0	3 * 1 = 3 SPACES	÷S .	10.2 SPACES PREVIOUSLY PURCHASED BY BUILDING OWNER TOTAL EXISTING: 23.2 SPACES	
OFFICE	1 space / 250 sqft	150 N CENTER : 0 156 N CENTER : 2,105 sqft	2,105 / 250 = 8.5 SPACES			

)					
USE	PARKING REQUIREMENTS	USE AREA		CALCULATION	TOTAL SPACES REQUIRED	PARKING SPACES PROVIDED		
RESTAURANT	1 space / 150 sqft	150-156 N CENTER: 3,525 sqft (NEW RESTAURANT 2,434 sqft / NEW TUSCAN 1,091 sqft)		3,525 / 150 = 23.5 SPACES	23.5 + 12 = 35.5 SPACES	EXISTING: 19.2 SPACES		
RESIDENTIAL	1 space / Bedroom	FIRST FLOOR	SECOND FLOOR	THIRD FLOOR	TOTAL	12 * 1 = 12 SPACES		THEREFORE, 16.3 PARKING SPACES WILL REQUIRE CASH IN LIE

EXISTING BUILDING SIZE

150 N CENTER:

156 N CENTER:

2.79

PROPOSED LOT COVERAGE | PROPOSED BUILDING SIZE


2,105 sqft

5,142 sqft 5,138 sqft 4,764 sqft

EXISTING LOT COVERAGE

FRONT LEAST SIDE TOTAL REAR N/A 20'

ONT CALCOLATIONS				
FLOOR	UNIT#	UNIT AREA	# BEDROOMS	# FLEX ROOMS
2	1	1,341 sqft	2	0
2	2	1,139 sqft	1	1
2	3	579 sqft	1	0
2	4	600 sqft	1	0
3	5	1,341 sqft	2	0
3	6	1,139 sqft	1	1
3	7	1,195 sqft	1	1
TOTALS	7	7,334 sqft	9	3

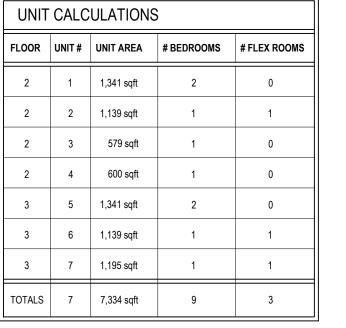

	EXISTING PHOTOGRAPHS		A100		•
	ARCHITECTURAL SITE PLAN		A101		
	FIRST LEVEL FLOOR PLAN		A102		Ŏ
	SECOND LEVEL FLOOR PLAN		A103		Ŏ
	THIRD LEVEL FLOOR PLAN		A104	Ŏ	Ŏ
	ROOF PLAN		A105	Ŏ	ě
	EXISTING EXTERIOR ELEVATIONS		A301		
	PROPOSED EXTERIOR ELEVATIONS		A302		ă
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Northville, MI 48167

150-156 North Center St.

FIRST FLOOR | SECOND FLOOR | THIRD FLOOR | BUILDING TOTAL | BUILDING FOOTPRINT FIRST FLOOR | SECOND FLOOR | THIRD FLOOR 150 N CENTER: RESTAURANT RESIDENTIAL **150 N CENTER:** 2721 / 1588 = 1.71 156 N CENTER: **156 N CENTER:** 2105 / 3795 = 0.55 PROPOSED BUILDING USE PROPOSED F.A.R. FIRST FLOOR | SECOND FLOOR | THIRD FLOOR | BUILDING TOTAL | BUILDING FOOTPRINT FIRST FLOOR SECOND FLOOR THIRD FLOOR **150-156 N CENTER:** RESTAURANT RESIDENTIAL RESIDENTIAL | **150-156 N CENTER:** 15,044 / 5,383 = 2.79 MAXIMUM FLOOR AREA RATIO MINIMUM LANDSCAPE AREA MAXIMUM LOT COVERAGE MINIMUM FLOOR AREA PROPOSED FOOTNOTES (a) PROPOSED BUILDING HEIGHT IS MEASURED TO THE FLAT ROOF ELEVATION. THE TOWER ELEMENT IS 41'-6"; THE HEIGHT TO THE TALLEST PARAPET IS 39'-4"; THE HEIGHT TO THE TOP OF THE ELEVATOR/STAIR TOWER IS 43'-8".


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ZONE IS TO REDUCE TRAFFIC IN THE EXISTING PARKING LOT.

(b) THE PROJECT IS SEEKING PLANNING COMMISSION APPROVAL FOR A ZERO (0) REAR YARD SETBACK, AS THE PROJECT

PROPOSES TO UTILIZE A NEWLY CONSTRUCTED DROP OFF AND LOADING ZONE ALONG DUNLAP STREET. THE INTENTION OF THIS

LOCATION MAP

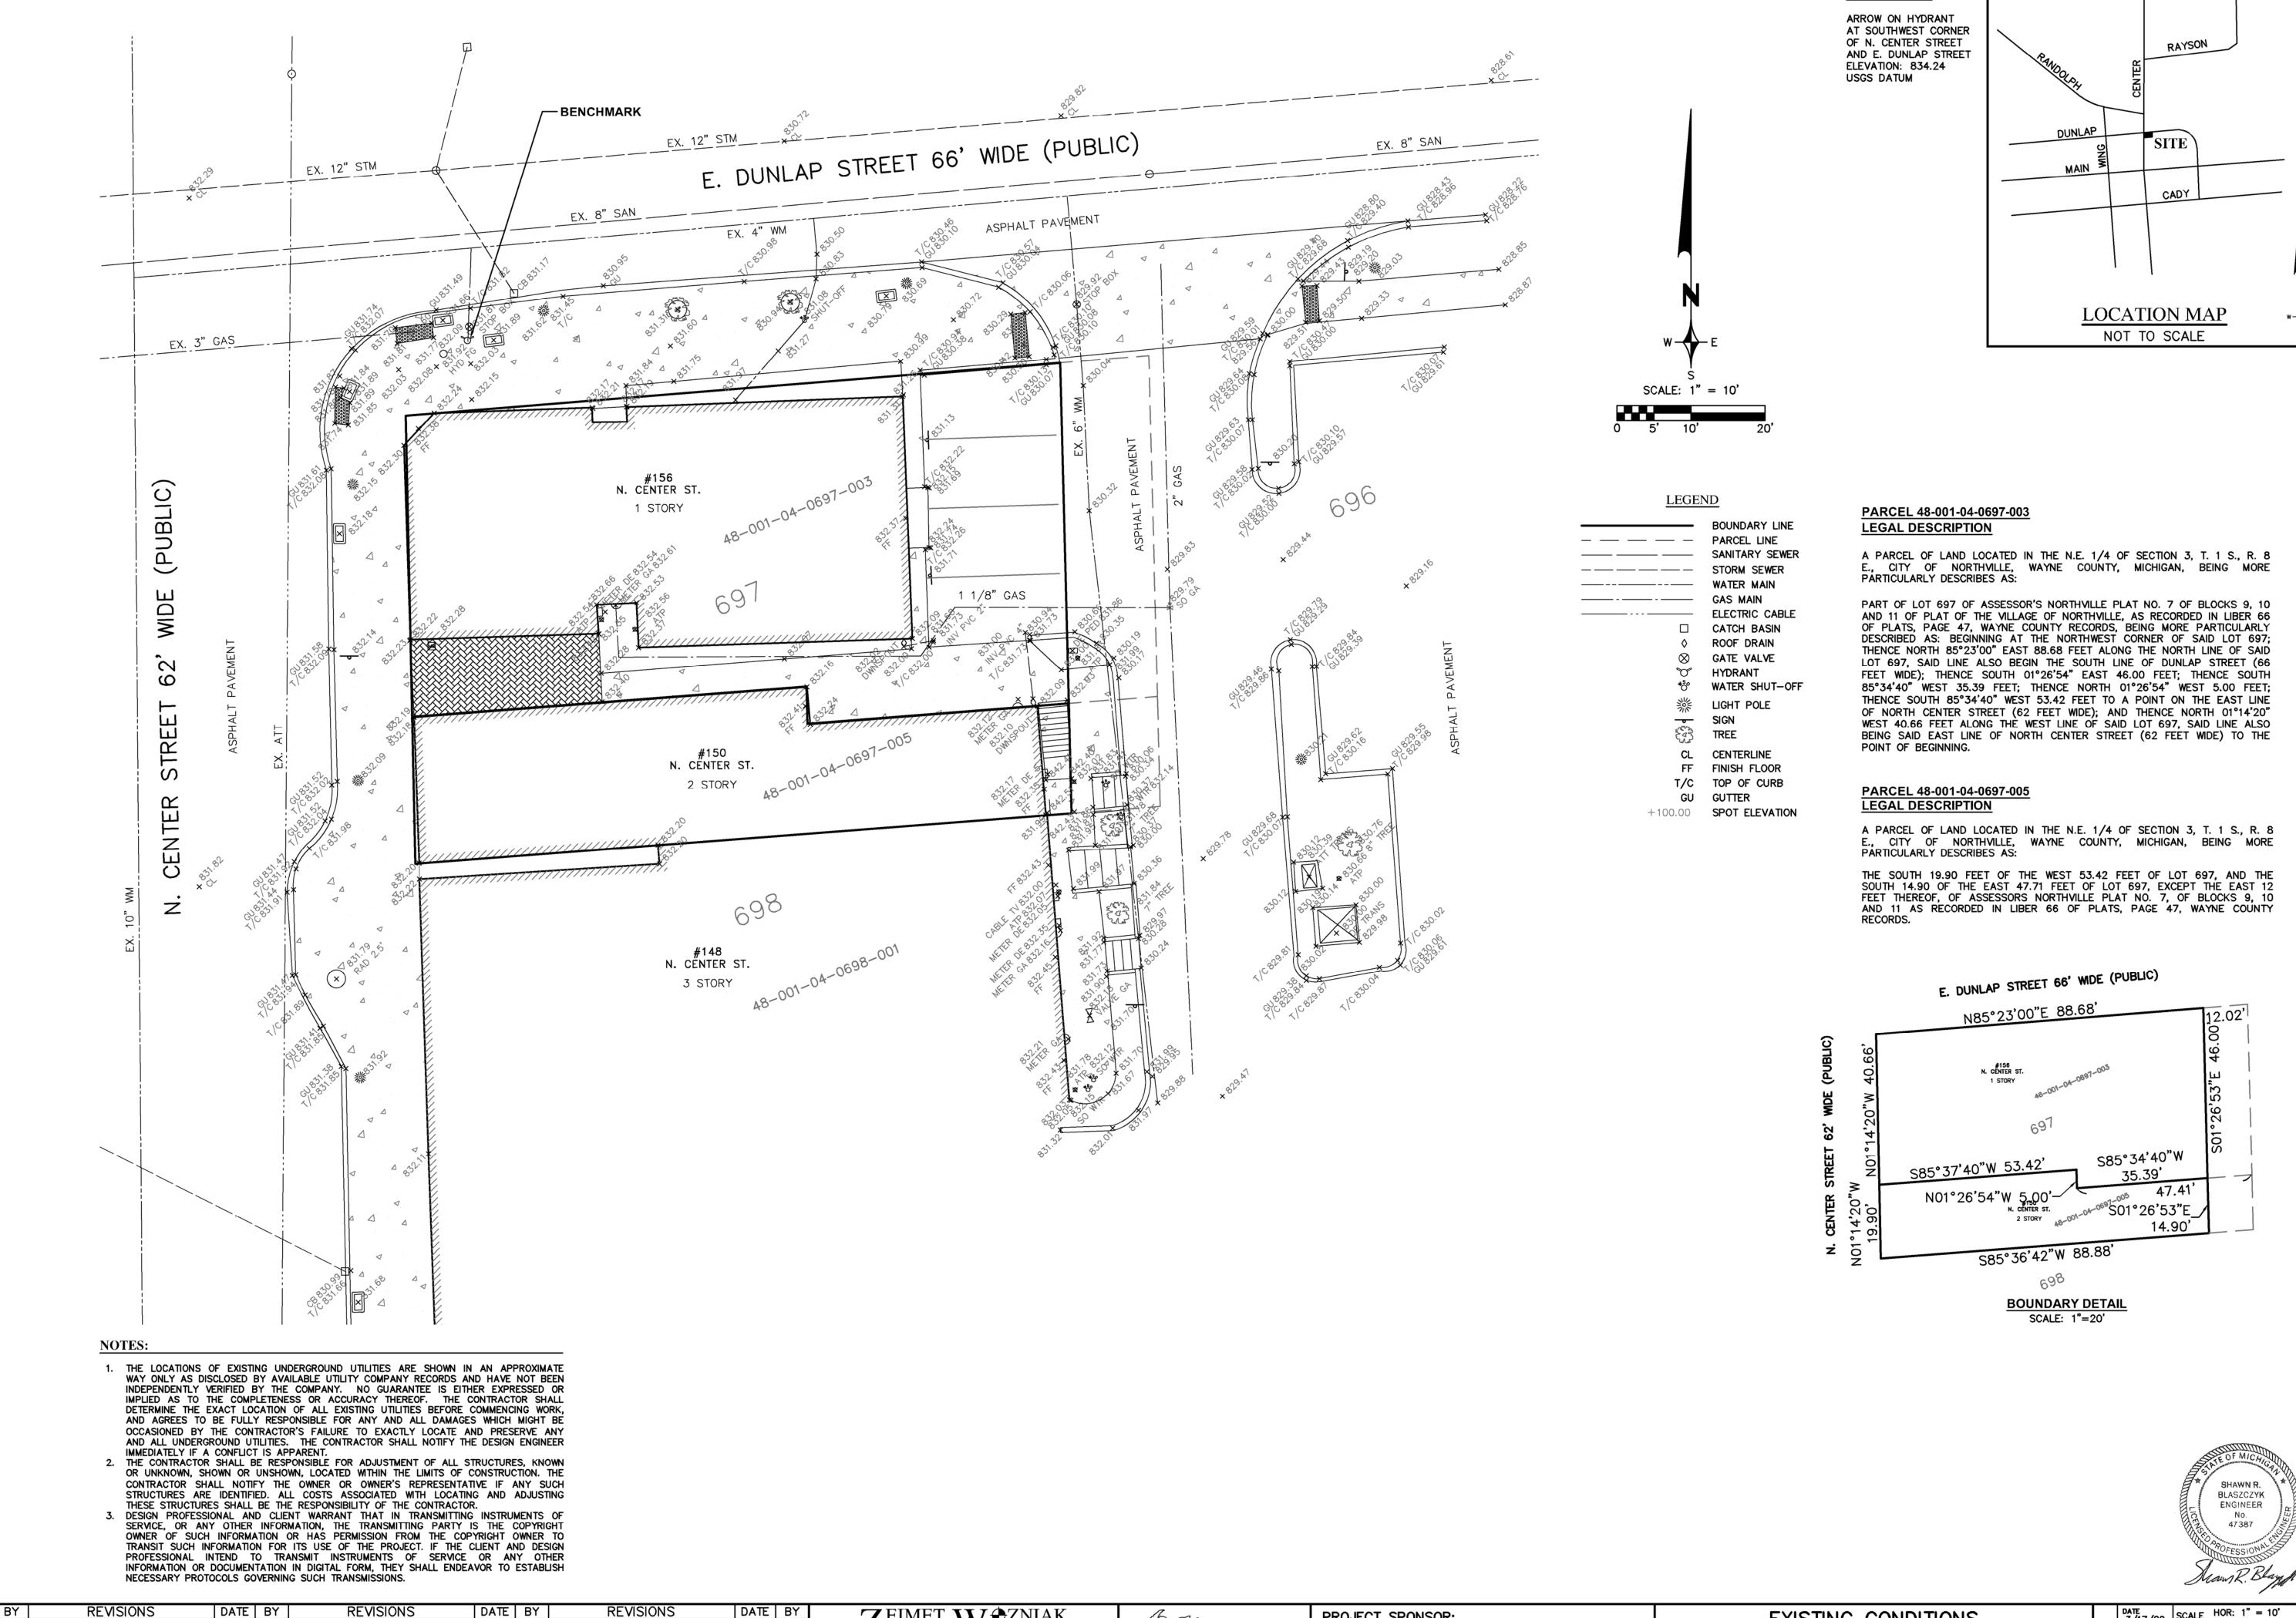

REVISIONS

ZEIMET W& ZNIAK
ASSOCIATES PROJECT SPONSOR: EXISTING CONDITIONS THREE FULL M ARCHITECTS WORKING DAYS 156 N. CENTER STREET Civil Engineers & Land Surveyors BEFORE YOU DIG, MISS DIG SYSTEM, INC. CALL THE MISS 114 RAYSON ST., STE. 2C 55800 GRAND RIVER AVE., SUITE 100 NEW HUDSON, MICHIGAN 48165 DIG SYSTEM 1-800-482-7171 248.349.2708 NORTHVILLE, MICHIGAN NORTHVILLE, MI 48167 P: (248) 437-5099 F: (248) 437-5222 www.zeimetwozniak.com

SCALE HOR: 1" = 10' $\frac{3}{17}$ /20 SCALE HOR: 1" = N/A

DESIGNED BY SRB JOB NO. 19125

DRAWN BY SRB SHEET S—1

BENCHMARK:

OR UNKNOWN, SHOWN OR UNSHOWN, LOCATED WITHIN THE LIMITS OF CONSTRUCTION. THE


CONTRACTOR SHALL NOTIFY THE OWNER OR OWNER'S REPRESENTATIVE IF ANY SUCH

STRUCTURES ARE IDENTIFIED. ALL COSTS ASSOCIATED WITH LOCATING AND ADJUSTING

3. DESIGN PROFESSIONAL AND CLIENT WARRANT THAT IN TRANSMITTING INSTRUMENTS OF SERVICE, OR ANY OTHER INFORMATION, THE TRANSMITTING PARTY IS THE COPYRIGHT OWNER OF SUCH INFORMATION OR HAS PERMISSION FROM THE COPYRIGHT OWNER TO TRANSIT SUCH INFORMATION FOR ITS USE OF THE PROJECT. IF THE CLIENT AND DESIGN PROFESSIONAL INTEND TO TRANSMIT INSTRUMENTS OF SERVICE OR ANY OTHER INFORMATION OR DOCUMENTATION IN DIGITAL FORM, THEY SHALL ENDEAVOR TO ESTABLISH


THESE STRUCTURES SHALL BE THE RESPONSIBILITY OF THE CONTRACTOR.

NECESSARY PROTOCOLS GOVERNING SUCH TRANSMISSIONS.

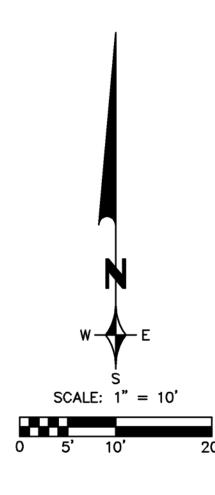

REMOVALS LEGEND:


REMOVE BUILDING AND FOUNDATION

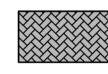

REMOVE EXISTING BRICK PAVERS



REMOVE EXISTING ASPHALT PAVEMENT AND BASE

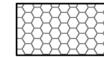

REMOVE EXISTING CONCRETE



REMOVE EXISTING LANDSCAPING/VEGETATION

REMOVE EXISTING WALL

FULL DEPTH SAWCUT
(EXACT LIMITS TO BE DETEMINED IN FIELD)



INLET FILTER (SILT SACK)

NOTE KEY:


- ① REMOVE EXISTING PVC PIPE.
- ② REMOVE EXISTING GAS METER.
 (COORDINATE WITH GAS COMPANY)
- ③ REMOVE EXISTING ELECTRIC METER. (COORDINATE WITH ELECTRIC COMPANY)
- CUT AND CAP EXISTING WATER SERVICE AT SHUT-OFF.
 (COORDINATE WITH CITY DPW)
- (5) REMOVE EXISTING PEDESTAL.
- (COORDINATE WITH UTILITY COMPANY)
- (COORDINATE WITH POSTAL SERVICE)
- REMOVE EXISTING TREE, ROOTS, STUMP AND WELL.
- 8 REMOVE EXISTING LIGHT POLE, ELECTRICAL BOX AND BASE.
- PROTECT EXISTING LIGHT POLE THROUGHOUT CONSTRUCTION.
- PROTECT EXISTING HYDRANT THROUGHOUT CONSTRUCTION.
- 11) REMOVE EXISTING GAS SERVICE. CUT AND CAP AT
- (2) LOCATION OF EXISTING SANITARY SERVICE IS UNKNOWN. CONTRACTOR TO LOCATE IN FIELD AND CUT CAP SERVICE OUTSIDE OF PROPOSED BUILDING LIMITS.
- (3) REMOVE EXISTING SIGN AND POST.
- (14) REMOVE EXISTING WALL.
- O DEMOVE EXISTING GTED
- 15 REMOVE EXISTING STEPS.
- (6) REMOVE EXISTING STAIRWAY.(7) ADJUST EXISTING SHUT-OFF TO PROPOSED GRADE.
- (8) PROTECT EXISTING TREE THROUGHOUT CONSTRUCTION.

SHAWN R.
BLASZCZYK
ENGINEER
NO.
47387

MARINE R.
BLASZCZYK
ENGINEER
NO.
47387

BLASZCZYK
ENGINEER
NO.
BLASZCZYK
ENGINEER
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REVISIONS REVISIONS DATE BY REVISIONS DATE BY REVISIONS DATE 3/17/20 SCALE HOR: 1" = 10' VER: 1" = N/A DATE | BY | ZEIMET W. DZNIAK SITE PREPARATION PLAN PROJECT SPONSOR: THREE FULL M ARCHITECTS DESIGNED BY SRB WORKING DAYS 156 N. CENTER STREET JOB NO. 19125 Civil Engineers & Land Surveyors BEFORE YOU DIG, MISS DIG SYSTEM, INC. CALL THE MISS 114 RAYSON ST., STE. 2C 55800 GRAND RIVER AVE., SUITE 100 NORTHVILLE, MICHIGAN DIG SYSTEM NEW HUDSON, MICHIGAN 48165 NORTHVILLE, MI 48167 1-800-482-7171 248.349.2708 SHEET S-2P: (248) 437-5099 F: (248) 437-5222 www.zeimetwozniak.com

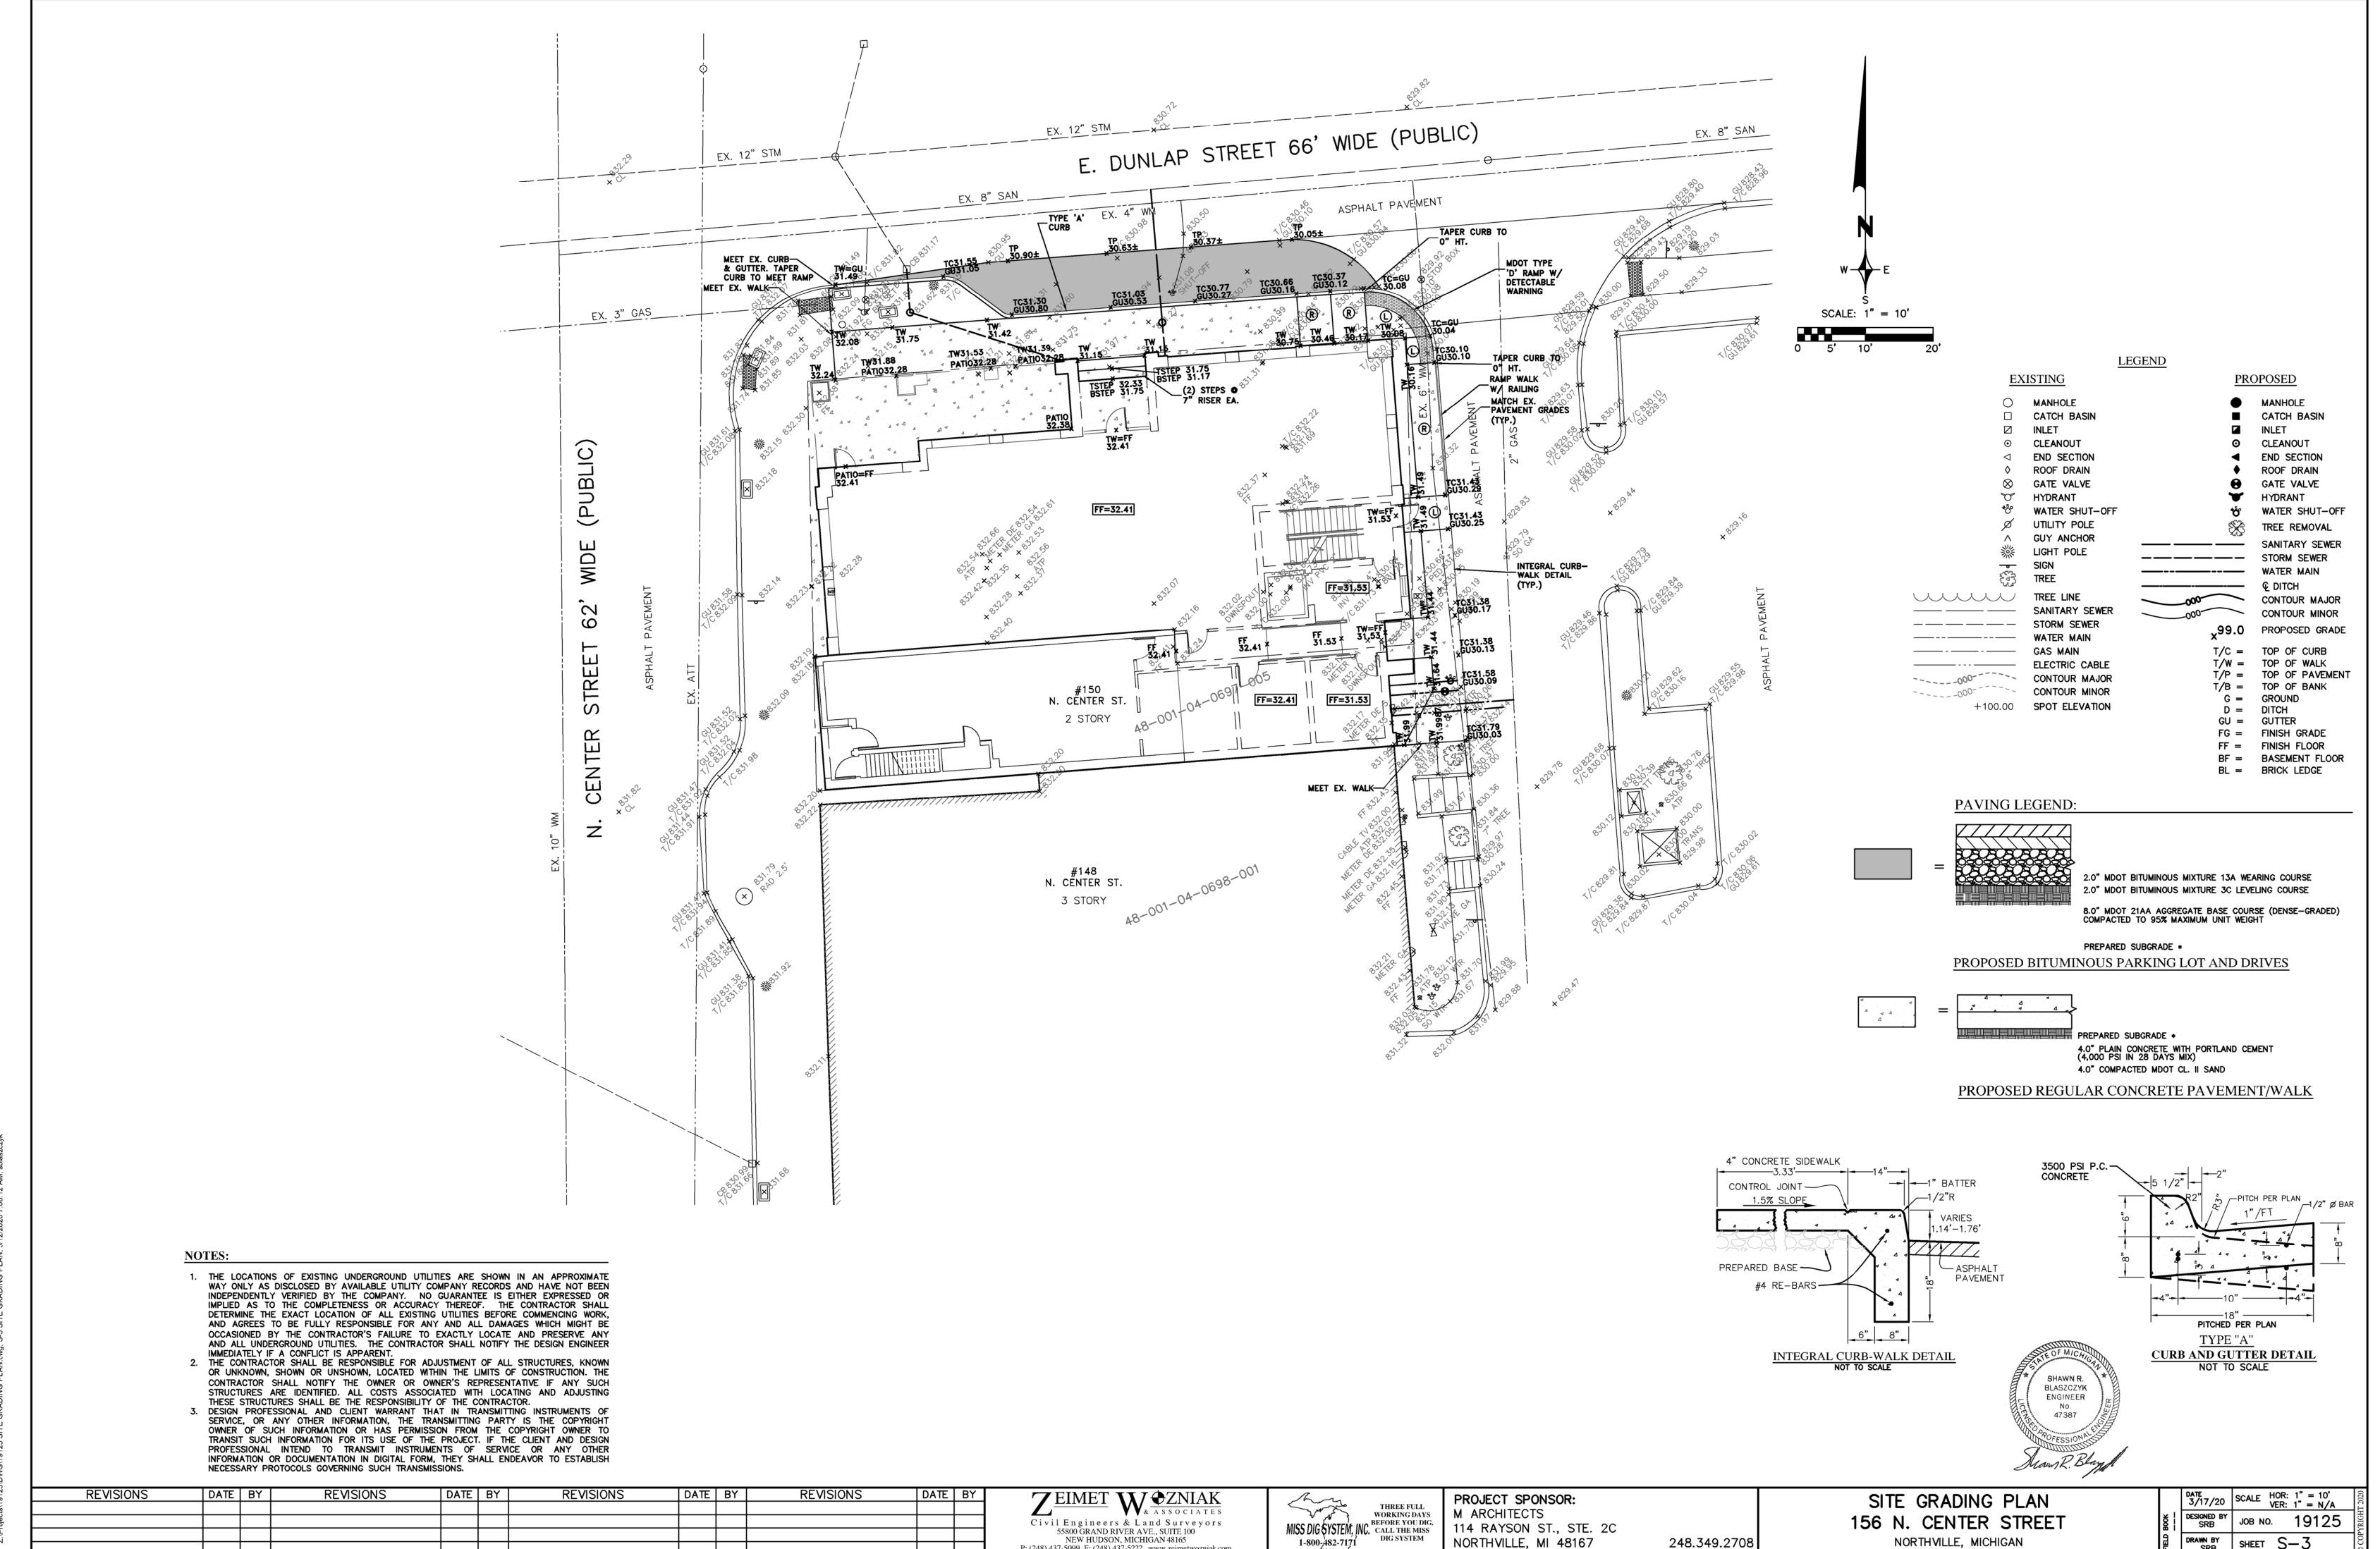

1-800<u>-482</u>-7171

P: (248) 437-5099 F: (248) 437-5222 www.zeimetwozniak.com

NORTHVILLE, MI 48167

SHEET S-3

- 2. IT SHALL BE THE CONTRACTORS RESPONSIBILITY TO VERIFY AND/OR OBTAIN ANY INFORMATION NECESSARY
- REGARDING THE PRESENCE OF UNDERGROUND UTILITIES, WHICH MIGHT AFFECT THIS JOB. 3. ALL TRENCHES UNDER OR WITHIN THREE (3) FEET OR THE FORTY-FIVE (45) DEGREE ZONE OF INFLUENCE LINE OF EXISTING AND/OR PROPOSED PAVEMENT, BUILDING PAD OR DRIVE APPROACH SHALL BE BACKFILLED WITH SAND COMPACTED TO AT LEAST NINETY-FIVE (95) PERCENT OF MAXIMUM UNIT WEIGHT (ASTM D-1557). ALL OTHER TRENCHES TO BE COMPACTED TO 90% OR BETTER.
- 4. WHENEVER EXISTING MANHOLES OR SEWER PIPE ARE TO BE TAPPED, DRILL HOLES 4" CENTER TO CENTER, AROUND PERIPHERY OF OPENING TO CREATE A PLANE OF WEAKNESS JOINT BEFORE BREAKING SECTION
- 5. EXACT GRADES AND DEPTHS OF UTILITIES ARE TO BE CHECKED CLOSELY PRIOR TO INSTALLATION.
- 6. REFER TO CITY OF NORTHVILLE STANDARD DETAIL SHEETS FOR ADDITIONAL INFORMATION.

SANITARY SEWER NOTES:


- 1. DOWNSPOUTS, WEEP TILE, FOOTING DRAINS OR ANY CONDUIT THAT CARRIES STORM OR GROUND WATER SHALL NOT BE ALLOWED TO DISCHARGE INTO A SANITARY SEWER.
- 2. ALL SANITARY LEADS SHALL BE CONSTRUCTED OF PVC SDR 23.5 AT 1.00% MINIMUM SLOPE WITH A MINIMUM DIAMETER OF 6 INCHES.
- 3. ALL SANITARY SEWER MAIN SHALL BE CONSIDERED OF SDR 26 PIPE WITH A MINIMUM DIAMETER OF 8'' PER CITY REQUIREMENTS.
- 4. JOINTS FOR P.V.C SOLID WALL PIPE SHALL BE ELASTOMERTRIC (RUBBER GASKET) AS SPECIFIED IN ASTM DESIGNATION D-3212.
- REFER TO CITY OF NORTHVILLE DETAILS FOR PIPE BEDDING DETAILS.
- 6. REFER TO CITY OF NORTHVILLE SANITARY SEWER DETAIL SHEETS FOR ADDITIONAL INFORMATION.

WATER MAIN NOTES:

- 1. ALL WATER MAIN SHALL BE INSTALLED WITH A MINIMUM COVER OF 6.0' BELOW FINISH GRADE. WHEN WATER MAINS MUST DIP TO PASS UNDER A STORM SEWER OR SANITARY SEWER, THE SECTIONS WHICH ARE DEEPER THAN NORMAL SHALL BE KEPT TO A MINIMUM LENGTH BY THE USE OF VERTICAL TWENTY TWO AND A HALF (22.5°) DEGREE BENDS, PROPERLY ANCHORED.
- 2. ALL WORKMANSHIP AND MATERIALS SHALL BE IN ACCORDANCE WITH THE CURRENT STANDARDS AND SPECIFICATIONS OF THE CITY OF NORTHVILLE.
- 3. ALL TRENCHES UNDER OR WITHIN THREE (3) FEET OR THE FORTY FIVE (45°) DEGREE ZONE OF INFLUENCE LINE OF EXISTING AND/OR PROPOSED PAVEMENT, BUILDING PAD OR DRIVE APPROACH SHALL BE BACKFILLED WITH SAND COMPACTED TO AT LEAST NINETY-FIVE (95%) PERCENT OF MAXIMUM UNIT WEIGHT (ASTM D-1557). ALL OTHER TRENCHES TO BE COMPACTED TO 90% OR BETTER.
- ALL TEE'S, BENDS, CONNECTIONS, ETC. ARE CONSIDERED INCIDENTAL TO THE JOB. PHYSICAL CONNECTIONS SHALL NOT BE MADE BETWEEN EXISTING AND NEW WATER MAINS UNTIL TESTING IS
- SATISFACTORILY COMPLETED. MAINTAIN 10' HORIZONTAL CLEARANCE BETWEEN OUTER EDGE OF WATER MAIN AND ANY SANITARY SEWER
- OR STRUCTURE.
- 7. ALL WATER MAIN 3 INCHES OR LARGER SHALL BE DUCTILE IRON CLASS 54 WITH POLYETHYLENE WRAP. ALL WATER SERVICES SMALLER THAN 3 INCHES SHALL BE TYPE ''K'' COPPER.
- 9. REFER TO CITY OF NORTHVILLE WATER MAIN DETAIL SHEETS FOR ADDITIONAL INFORMATION.

STORM SEWER NOTES:

- ALL STORM SEWER 12" AND LARGER SHALL BE RCP CLASS IV UNLESS OTHERWISE NOTED. REFER TO CITY OF NORTHVILLE STANDARD DETAILS SHEET FOR STANDARD BEDDING DETAILS.
- JOINTS FOR ALL STORM SEWER 12" AND LARGER SHALL BE MODIFIED TONGUE AND GROOVE JOINT WITH RUBBER GASKETS UNLESS SPECIFIED OTHERWISE (ASTM C-443).
- ALL STORM SEWER LEADS SHALL BE CONSTRUCTED OF PVC SDR 23.5 PIPE AT 1.00% MINIMUM SLOPE WITH GLUED JOINTS, UNLESS OTHERWISE NOTED. REFER TO CITY OF NORTHVILLE DETAILS FOR BEDDING
- REFER TO CITY OF NORTHVILLE STORM SEWER DETAIL SHEETS FOR ADDITIONAL INFORMATION.

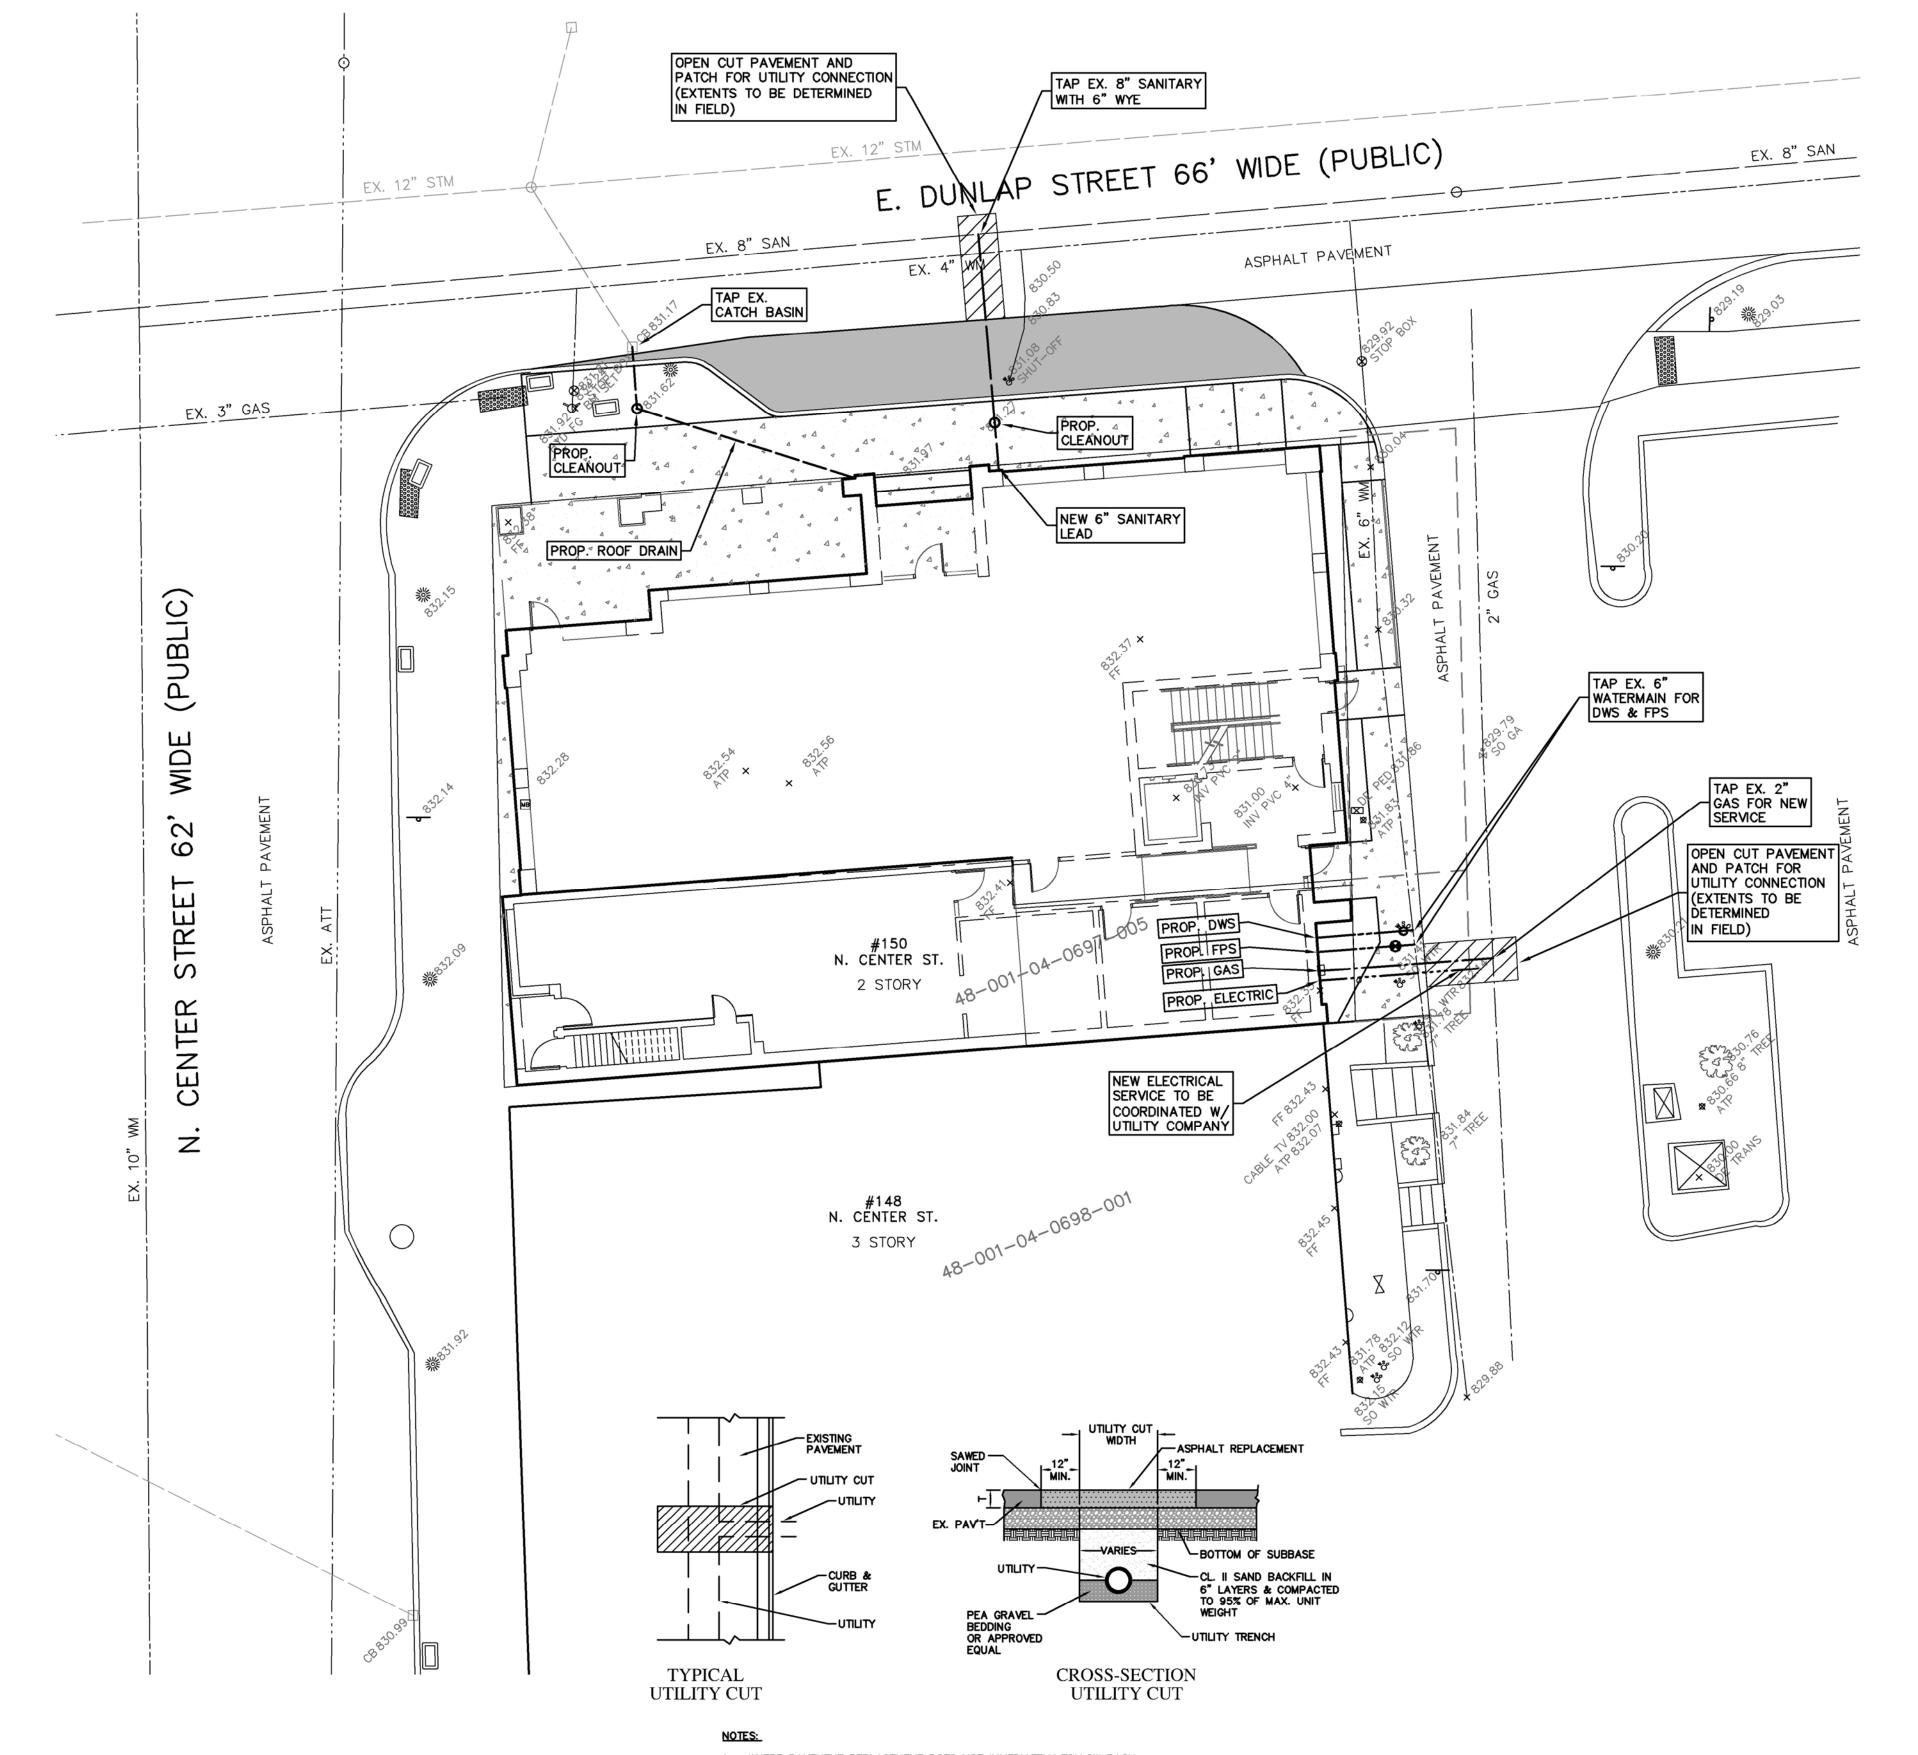

- THE LOCATIONS OF EXISTING UNDERGROUND UTILITIES ARE SHOWN IN AN APPROXIMATE WAY ONLY AS DISCLOSED BY AVAILABLE UTILITY COMPANY RECORDS AND HAVE NOT BEEN INDEPENDENTLY VERIFIED BY THE COMPANY. NO GUARANTEE IS EITHER EXPRESSED OR IMPLIED AS TO THE COMPLETENESS OR ACCURACY THEREOF. THE CONTRACTOR SHALL DETERMINE THE EXACT LOCATION OF ALL EXISTING UTILITIES BEFORE COMMENCING WORK, AND AGREES TO BE FULLY RESPONSIBLE FOR ANY AND ALL DAMAGES WHICH MIGHT BE OCCASIONED BY THE CONTRACTOR'S FAILURE TO EXACTLY LOCATE AND PRESERVE ANY AND ALL UNDERGROUND UTILITIES. THE CONTRACTOR SHALL NOTIFY THE DESIGN ENGINEER IMMEDIATELY IF A CONFLICT IS APPARENT.
- THE CONTRACTOR SHALL BE RESPONSIBLE FOR ADJUSTMENT OF ALL STRUCTURES. KNOWN OR UNKNOWN, SHOWN OR UNSHOWN, LOCATED WITHIN THE LIMITS OF CONSTRUCTION. THE CONTRACTOR SHALL NOTIFY THE OWNER OR OWNER'S REPRESENTATIVE IF ANY SUCH STRUCTURES ARE IDENTIFIED. ALL COSTS ASSOCIATED WITH LOCATING AND ADJUSTING THESE STRUCTURES SHALL BE THE RESPONSIBILITY OF THE CONTRACTOR.
- DESIGN PROFESSIONAL AND CLIENT WARRANT THAT IN TRANSMITTING INSTRUMENTS OF SERVICE, OR ANY OTHER INFORMATION, THE TRANSMITTING PARTY IS THE COPYRIGHT OWNER OF SUCH INFORMATION OR HAS PERMISSION FROM THE COPYRIGHT OWNER TO TRANSIT SUCH INFORMATION FOR ITS USE OF THE PROJECT. IF THE CLIENT AND DESIGN PROFESSIONAL INTEND TO TRANSMIT INSTRUMENTS OF SERVICE OR ANY OTHER INFORMATION OR DOCUMENTATION IN DIGITAL FORM, THEY SHALL ENDEAVOR TO ESTABLISH NECESSARY PROTOCOLS GOVERNING SUCH TRANSMISSIONS.

- WHERE PAVEMENT REPLACEMENT DOES NOT IMMEDIATELY FOLLOW BACK-FILL OPERATION, A TEMPORARY SURFACING SHALL BE PLACED AS DIRECTED BY THE CITY ENGINEER.
- 2. ASPHALT PAVEMENT SHALL MEET CURRENT M.DOT SPECIFICATIONS. 3. WHEN REPLACING PAVEMENT, REPLACE IN KIND AND THICKNESS.
- 4. THE BACKFILL SHALL BE PLACED IN LAYERS NOT TO EXCEED 9" IN THICKNESS, AND COMPACTED WITH A MECHANICALLY OPERATED HAND-HELD VIBRATING OR IMPACT TYPE COMPACTOR. WHEN CONTROLLED DENSITY IS CALLED FOR, BACKFILL AND COMPACTION SHALL BE IN ACCORDANCE WITH THE STANDARD
- 5. WHEN THE PATCH IS AGGREGATE AND BITUMINOUS, THE ASPHALTIC MIXTURE SHALL BE #1100 OR BETTER. COMPACTION SHALL BE ACCOMPLISHED BY MEANS OF A POWERED ROLLER OR VIBRATORY COMPACTOR.
- WHEN CURB, CURB AND GUTTER, VALLEY GUTTER AND/OR SHOULDERS ARE REMOVED OR DAMAGED AS PART OF THE UTILITY CUT, THEY SHALL BE REPAIRED
- OR REPLACED IN KIND USING TIE BARS. 7. EXCESS EXCAVATED MATERIAL SHALL BE PROMPTLY REMOVED.

UTILITY CUT AND PAVEMENT REPLACEMENT NOT TO SCALE

SITE UTILITY PLAN PROJECT SPONSOR: THREE FULL M ARCHITECTS WORKING DAYS DESIGNED BY SRB 156 N. CENTER STREET BEFORE YOU DIG.

248.349.2708

REVISIONS DATE | BY REVISIONS DATE BY REVISIONS

ZEIMET W& ZNIAK
ASSOCIATES Civil Engineers & Land Surveyors 55800 GRAND RIVER AVE., SUITE 100 NEW HUDSON, MICHIGAN 48165

P: (248) 437-5099 F: (248) 437-5222 www.zeimetwozniak.com

MISS DIG SYSTEM, INC. CALL THE MISS DIG SYSTEM 1-800-482-7171

114 RAYSON ST., STE. 2C NORTHVILLE, MI 48167

NORTHVILLE, MICHIGAN

DATE 3/17/20 SCALE HOR: 1" = 10' VER: 1" = N/A JOB NO. 19125 SHEET S-4

BLASZCZYK

ENGINEER

SCALE: 1" = 10

UTILITY LEGEND

EXISTING

MANHOLE

INLET

CATCH BASIN

CLEANOUT

END SECTION

ROOF DRAIN

UTILITY POLE

GUY ANCHOR

LIGHT POLE

SIGN

TREE

---- GAS MAIN

PROPOSED

TREE LINE

WATER SHUT-OFF

SANITARY SEWER

STORM SEWER

WATER MAIN

— ELECTRIC CABLE

MANHOLE

CATCH BASIN INLET

> CLEANOUT END SECTION

ROOF DRAIN GATE VALVE HYDRANT

WATER MAIN € DITCH

— SANITARY SEWER

WATER SHUT-OFF TREE REMOVAL

GATE VALVE

HYDRANT

DUNLAP STREET CONSTRUCTION NOTES:

- 1. ALL WORK WITHIN THE DUNLAP STREET R.O.W. SHALL BE TO CURRENT CITY OF NORTHVILLE STANDARDS AND SPECIFICATIONS.
- TRAFFIC CONTROL IS THE RESPONSIBILITY OF THE CONTRACTOR.
- 3. ANY STRUCTURES WITHIN THE PROPOSED WORK AREA SHOULD BE ADJUSTED AND CHANGED AS NEEDED TO MATCH PROPOSED CONDITION. STRUCTURES SHALL BE REPAIRED OR RECONSTRUCTED AS NEEDED.
- 4. RESTORE ALL DISTURBED NON-PAVED AREAS WITH A MINIMUM 3" TOPSOIL, SEED AND MULCH.
- 5. MAINTAIN TWO-WAY TRAFFIC AT ALL TIMES.
- 6. CONTRACTOR SHALL NOT POUR CURBS AND GUTTERS UNTIL FORMS ARE CHECKED AND APPROVED BY THE CITY
- 7. ALL MUD AND DIRT TRACKED ONTO EXISTING ROADS FROM THIS SITE DUE TO CONSTRUCTION SHALL BE PROMPTLY REMOVED BY THE CONTRACTOR.
- 8 "PROPER SIGNING" IS REQUIRED BEFORE ANY WORK IN RIGHT-OF-WAY IS STARTED.
- LANE CLOSURES RESTRICTED TO 9 AM TO 3 PM, MONDAY TO FRIDAY.
- 10. FIXED OBJECTS SHALL BE A MINIMUM 6 FEET FROM THE BACK OF THE FINISHED CURB LINE. REMOVE OR RELOCATE ALL FIXED OBJECTS PRIOR TO EXCAVATION.
- 11. ANY PEDESTRIAN FACILITIES SHALL BE CONSTRUCTED IN ACCORDANCE WITH CURRENT AMERICANS WITH DISABILITIES ACT (ADA) GUIDELINES.
- 12. EXCAVATIONS WITHIN A 1:1 INFLUENCE OF THE ROADWAY WILL REQUIRE MOOT CLASS II BACKFILL COMPACTED TO 95% MAXIMUM DENSITY.
- MATCH AND TIE PROPOSED CURB TO EXISTING CURB. EPOXY COATED #4 REBAR REQUIRED.

GENERAL SITE NOTES:

- ALL WORK SHALL CONFORM TO THE CURRENT CITY OF NORTHVILLE STANDARDS AND SPECIFICATIONS.
- 2. ALL PARKING AND TRAFFIC CONTROL SIGNS SHALL COMPLY WITH THE DESIGN AND PLACEMENT REQUIREMENTS OF THE CURRENT EDITION OF THE "MICHIGAN MANUAL OF UNIFORM TRAFFIC CONTROL DEVICES" (MMUTCD).
- 3. CONTRACTOR SHALL NOTIFY THE CITY OF NORTHVILLE A MINIMUM OF 72 HOURS PRIOR TO THE START OF ANY WORK.
- CALL MISS DIG (811) A MINIMUM OF 72 HOURS PRIOR TO THE START OF CONSTRUCTION.
- ALL SOIL EROSION AND SILT MUST BE CONTROLLED AND CONTAINED ON SITE.
- 6. ALL EXCAVATION UNDER OR WITHIN A 1:1 INFLUENCE OF PAVEMENT, EXISTING OR PROPOSED SHALL BE BACKFILLED AND COMPACTED WITH SAND (MDOT CLASS II MATERIAL).
- 7. THE CONTRACTOR IS RESPONSIBLE FOR ALL DAMAGE TO EXISTING UTILITIES, CURBS, WALKS, DRIVES, ETC. AS A RESULT OF HIS OPERATIONS.
- 8. IF DEWATERING IS ANTICIPATED OR ENCOUNTERED DURING CONSTRUCTION, THE CONTRACTOR IS REQUIRED TO SUBMIT A DEWATERING PLAN TO THE CITY FOR REVIEW.
- 9. CONTRACTOR SHALL FIELD VERIFY THE LOCATION, DEPTH, AND SIZE OF ALL EXISTING UTILITIES PRIOR TO THE START OF CONSTRUCTION AND SHALL NOTIFY THE DESIGN ENGINEER IF ANY CONFLICTS ARE APPARENT.

GRADING NOTES:

- 1. ALL CONSTRUCTION AND MATERIALS SHALL BE IN ACCORDANCE WITH THE CURRENT STANDARDS AND SPECIFICATIONS OF THE CITY OF NORTHVILLE.
- 2. ALL NECESSARY PERMITS, TESTING, BONDS AND INSURANCE ETC., SHALL BE PAID FOR BY THE CONTRACTOR. THE OWNER SHALL PAY FOR ALL THE CITY INSPECTION FEES.
- 3. THE CONTRACTOR SHALL BE RESPONSIBLE FOR DUST CONTROL DURING THE PERIODS OF CONSTRUCTION. THIS SHALL BE CONSIDERED INCIDENTAL TO THE JOB.
- 4. PRIOR TO ANY EXCAVATION, THE CONTRACTOR SHALL CONTACT MISS DIG (811) TO VERIFY THE LOCATION OF ANY EXISTING UNDERGROUND UTILITIES AND SHALL NOTIFY OTHER REPRESENTATIVES OF OTHER UTILITIES IN THE VICINITY OF THE WORK.
- 5. ALL PROPERTIES OR FACILITIES IN THE SURROUNDING AREAS, PUBLIC OR PRIVATE, DESTROYED OR OTHERWISE DISTURBED DUE TO CONSTRUCTION SHALL BE REPLACED AND/OR RESTORED TO THE ORIGINAL CONDITION BY THE CONTRACTOR.
- 6. MANHOLE, CATCH BASIN, GATE VALVES AND HYDRANT FINISH GRADES MUST BE CLOSELY CHECKED AND APPROVED BY THE ENGINEER BEFORE THE CONTRACTOR'S WORK IS CONSIDERED COMPLETE.
- 7. CONTRACTOR SHALL REMOVE AND DISPOSE OF OFF-SITE ANY TREES, BRUSH, STUMPS, TRASH OR OTHER UNWANTED DEBRIS AT THE OWNER'S DIRECTION, INCLUDING OLD BUILDING FOUNDATIONS AND FLOORS. BURNING OF TRASH, STUMPS OR OTHER DEBRIS SHALL NOT BE PERMITTED.
- 8. THE CONTRACTOR SHALL PROVIDE ALL NECESSARY BARRICADING, LIGHTS AND TRAFFIC CONTROL DEVICES TO PROTECT THE WORK AND SAFELY CONTAIN TRAFFIC IN ACCORDANCE WITH ''MMUTCD''.
- 9. ALL EXCAVATIONS SHALL BE SLOPED, SHORED OR BRACED IN ACCORDANCE WITH MI-OSHA REQUIREMENTS. THE CONTRACTOR SHALL PROVIDE AN ADEQUATELY CONSTRUCTED AND BRACED SHORING SYSTEM FOR EMPLOYEES WORKING IN AN EXCAVATION THAT MAY EXPOSE EMPLOYEES TO THE DANGER OF MOVING AROUND.
- ALL REFERENCES TO M.D.O.T. SPECIFICATIONS ARE TO BE IN ACCORDANCE WITH THE CURRENT STANDARD SPECIFICATIONS FOR CONSTRUCTION.

PAVING NOTES:

- 1. ALL WORKMANSHIP AND MATERIALS SHALL BE IN ACCORDANCE WITH THE CURRENT STANDARDS AND SPECIFICATIONS OF THE CITY OF NORTHVILLE AND M.D.O.T.
- 2. IN AREAS WHERE NEW PAVEMENTS ARE BEING CONSTRUCTED, THE TOPSOIL AND SOIL CONTAINING ORGANIC MATTER SHALL BE REMOVED PRIOR TO PAVEMENT CONSTRUCTION.
- 3. SUBGRADE UNDERCUTTING, INCLUDING BACKFILLING SHALL BE PERFORMED TO REPLACE MATERIALS SUSCEPTIBLE TO FROST HEAVING AND UNSTABLE SOIL CONDITIONS. ANY EXCAVATIONS THAT MAY BE REQUIRED BELOW THE TOPSOIL IN FILL SECTIONS OR BELOW SUBGRADE IN CUT SECTIONS, WILL BE CLASSIFIED AS SUBGRADE UNDERCUTTING.
- 4. SUBGRADE UNDERCUTTING SHALL BE PERFORMED WHERE NECESSARY AND THE EXCAVATED MATERIAL SHALL BECOME THE PROPERTY OF THE CONTRACTOR. ANY SUBGRADE UNDERCUTTING SHALL BE BACKFILLED WITH SAND OR OTHER SIMILAR APPROVED MATERIAL. BACKFILL SHALL BE COMPACTED TO 95% OF THE MAXIMUM UNIT WEIGHT (PER ASTM D-1557) UNLESS OTHERWISE SPECIFIED.
- BACKFILL UNDER PAVED AREAS SHALL BE AS SPECIFIED ON DETAILS.
- ANY SUB-GRADE WATERING REQUIRED TO ACHIEVE REQUIRED DENSITY SHALL BE CONSIDERED INCIDENTAL TO THE JOB.

TRAFFIC SIGNING AND STRIPING REQUIREMENTS:

- 1. ALL PARKING AND TRAFFIC CONTROL SIGNS SHALL COMPLY WITH THE DESIGN AND PLACEMENT REQUIREMENTS OF THE CURRENT EDITION OF THE "MICHIGAN MANUAL OF UNIFORM TRAFFIC CONTROL DEVICES" (MMUTCD).
- 2. SIGNS SHALL BE MOUNTED ON 1 1/2" SQUARE GALVANIZED STEEL POST, WALL, OR FENCE AS NOTED ON THE PLANS.
- 3. STRIPING FOR HANDICAPPED (BARRIER FREE) PARKING SPACES SHALL BE BLUE AND MARKINGS FOR NON-HANDICAPPED (STANDARD) PARKING SPACES SHALL BE WHITE. WHERE A HANDICAPPED PARKING SPACE ABUTS A NON-HANDICAPPED PARKING SPACE, THE TWO SPACES SHALL BE SEPARATED BY ABUTTING BLUE AND WHITE STRIPES.
- 4. EACH INTERNATIONAL SYMBOL OF ACCESSIBILITY (WHEELCHAIR) TO BE PAINTED ON THE PAVEMENT SHALL BE WHITE.

GENERAL LAYOUT NOTES:

- PLACE 1/2" EXPANSION PAPER AT ALL LOCATIONS WHERE NEW CONCRETE WALK ABUTS OR MEETS BUILDINGS, CONCRETE CURBS, EXISTING SIDEWALKS, AND RETAINING WALLS.
- INSTALL EXPANSION JOINTS IN CONCRETE WALKS AS FOLLOWS:
 - 6' WD. SIDEWALK 18' O.C. TYP.
 - 5' WD. SIDEWALK 20' O.C. TYP.
 - 4' WD. SIDEWALK 20' O.C. TYP. 3' WD. SIDEWALK — 18' O.C. TYP.
 - SEAL ALL EXPANSION JOINTS.
- INSTALL CONTROL JOINTS IN CONCRETE WALKS AS FOLLOWS:
 - 6' WD. SIDEWALK 6'X6' PANEL
 - 5' WD. SIDEWALK 5'X'5' PANEL
 - 4' WD. SIDEWALK 4'X'4' PANEL
 - 3' WD. SIDEWALK 3'X3' PANEL
 - ALL CONTROL JOINTS SHALL BE 1/4" WIDE AND SAWCUT TO 2" DEEP.
- ALL CONCRETE WALKS SHALL BE BROOM FINISHED PARALLEL TO JOINTS.


CONSTRUCTION NOTES:

- 1. IT SHALL BE THE CONTRACTOR'S RESPONSIBILITY TO VERIFY ALL EXISTING SURVEY INFORMATION INCLUDING UTILITY SYSTEMS BEFORE ANY DEMOLITION OR CONSTRUCTION WORK OCCURS. ANY DISCREPANCIES WITH THE SURVEY INFORMATION SHALL BE REPORTED TO THE CITY'S REPRESENTATIVE IMMEDIATELY.
- 2. CONTRACTOR SHALL CONTACT AND COORDINATE WITH ALL APPLICABLE UTILITY COMPANIES 72 HOURS IN ADVANCE OF ANY WORK.
- 3. CONTRACTOR SHALL BE RESPONSIBLE FOR MAKING HIMSELF FAMILIAR WITH ALL UNDERGROUND UTILITIES, PIPES AND STRUCTURES. CONTRACTOR SHALL TAKE SOLE RESPONSIBILITY FOR COST INCURRED DUE TO DAMAGE AND REPLACEMENT OF SAID UTILITIES.
- 4. ALL EXISTING CONDITIONS DESIGNATED TO REMAIN WITHIN THE NEW CONSTRUCTION AREA (INCLUDING MAILBOXES) SHALL BE PROPERLY AND ADEQUATELY PROTECTED FROM DAMAGE DURING DEMOLITION OPERATIONS AND THROUGHOUT CONSTRUCTION. IT SHALL BE THE RESPONSIBILITY OF THE CONTRACTOR TO RESTORE TO THE ORIGINAL CONDITION ANY OF THESE EXISTING ITEMS THAT ARE DAMAGED OR DISTURBED IN ANY WAY.
- 5. CONTRACTOR SHALL LIMIT ALL WORK AND DISTURBANCE TO WITHIN DESIGNATED PROJECT AREAS. IT SHALL BE THE RESPONSIBILITY OF THE CONTRACTOR TO RESTORE TO THE ORIGINAL CONDITION ANY DAMAGE OR DISTURBANCE OUTSIDE THESE
- 6. STREETS, SIDEWALKS AND ADJACENT PROPERTY SHALL BE PROTECTED THROUGHOUT THE WORK AS REQUIRED BY LOCAL CODES AND REGULATIONS AND APPROVED BY THE CITY.
- 7. ALL MATERIAL SPECIFIED TO BE REMOVED BECOMES THE PROPERTY OF THE CONTRACTOR AND SHALL BE DISPOSED OF OFF-SITE PER APPLICABLE CODES AND REGULATIONS EXCEPT THAT PRIOR TO DISPOSAL OF ANY CASTINGS, SIGNS, OR POSTS THEY SHALL BE MADE AVAILABLE TO THE CITY OF NORTHYLLE FOR THE CITY'S SALVAGE YARD.
- 8. DURING DEMOLITION OPERATIONS EVERY EFFORT SHALL BE MADE TO CONTROL DUST, PER CITY REQUIREMENTS.
- 10. DURING CONSTRUCTION THE CONTRACTOR SHALL PROVIDE WATCHMEN AND FLAGMEN AS MAY BE REQUIRED FOR THE SAFETY AND CONVENIENCE OF THE PUBLIC AND SHALL FURNISH ALL BARRICADES, SIGNS, AND LIGHTS NECESSARY TO PROTECT THE PUBLIC. TRAFFIC SHALL BE MAINTAINED AT ALL TIMES UNLESS OTHERWISE AUTHORIZED BY THE CITY OF NORTHVILLE. TRAFFIC CONTROL SHALL BE IN ACCORDANCE WITH THE MICHIGAN MANUAL OF TRAFFIC CONTROL DEVICES, CURRENT EDITION BY THE MICHIGAN DEPARTMENT OF TRANSPORTATION.


GENERAL SITE NOTES:

- ALL WORK SHALL CONFORM TO THE CURRENT CITY OF NORTHVILLE STANDARDS AND SPECIFICATIONS.
- 2. ALL NECESSARY PERMITS, TESTING, BONDS AND INSURANCE ETC., SHALL BE PAID FOR BY THE CONTRACTOR. THE OWNER SHALL PAY FOR ALL THE CITY INSPECTION FEES.
- 3. CONTRACTOR SHALL NOTIFY THE CITY OF NORTHVILLE A MINIMUM OF 72 HOURS PRIOR TO THE START OF ANY WORK.
- 4. CALL MISS DIG (811) A MINIMUM OF 72 HOURS PRIOR TO THE START OF CONSTRUCTION.
- 5. ALL SOIL EROSION AND SILT MUST BE CONTROLLED AND CONTAINED ON SITE.
- 6. ALL EXCAVATION UNDER OR WITHIN A 1:1 INFLUENCE OF PAVEMENT, EXISTING OR PROPOSED SHALL BE BACKFILLED AND COMPACTED WITH SAND (MDOT CLASS II MATERIAL).
- 7. THE CONTRACTOR IS RESPONSIBLE FOR ALL DAMAGE TO EXISTING UTILITIES, CURBS, WALKS, DRIVES, ETC. AS A RESULT OF HIS OPERATIONS.
- 8. IF DEWATERING IS ANTICIPATED OR ENCOUNTERED DURING CONSTRUCTION, THE CONTRACTOR IS REQUIRED TO SUBMIT A DEWATERING PLAN TO THE CITY FOR REVIEW.
- 9. CONTRACTOR SHALL FIELD VERIFY THE LOCATION, DEPTH, AND SIZE OF ALL EXISTING UTILITIES PRIOR TO THE START OF CONSTRUCTION AND SHALL NOTIFY THE DESIGN ENGINEER IF ANY CONFLICTS ARE APPARENT.



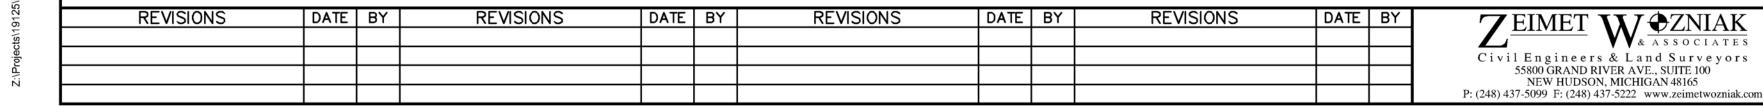



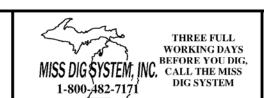

PROJECT SPONSOR: M ARCHITECTS 114 RAYSON ST., STE. 2C NORTHVILLE, MI 48167

248.349.2708

NOTES AND DETAILS 156 N. CENTER STREET NORTHVILLE, MICHIGAN

DATE 3/17/20 SCALE HOR: 1" = N/A VER: 1" = N/A JOB NO. 19125 SHEET S-5

ISSUE DATE

114 RAYSON STREET SUITE 2C NORTHVILLE,MICHIGAN 48167 PHONE 248.349.2708 marchitects.com

PROJECT NEW BUILDING AND BUILDING ADDITION

150 /156 North Center Street Northville, MI 481467

IMAGE NUMBER

IMAGE NUMBER

E-1.0

E-4.0

PROJECT ADDRESS

150 / 156 North Center Street Northville, MI 48167

PROJECT NUMBER

19.18

SHEET NAME EXISTIELG PHOTOGRAPHS

S H E E T N U M B E R A189

EXISTING LOOKING EAST



EXISTING LOOKING NORTHEAST



EXISTING LOOKING NORTHWEST





EXISTING LOOKING SOUTHEAST





EXISTING LOOKING SOUTH

IMAGE NUMBER

IMAGE NUMBER

E-3.0

E-6.0

EXISTING LOOKING SOUTHEAST

EXISTING LOOKING WEST



IMAGE NUMBER


E-2.0







EXISTING LOOKING SOUTHWEST



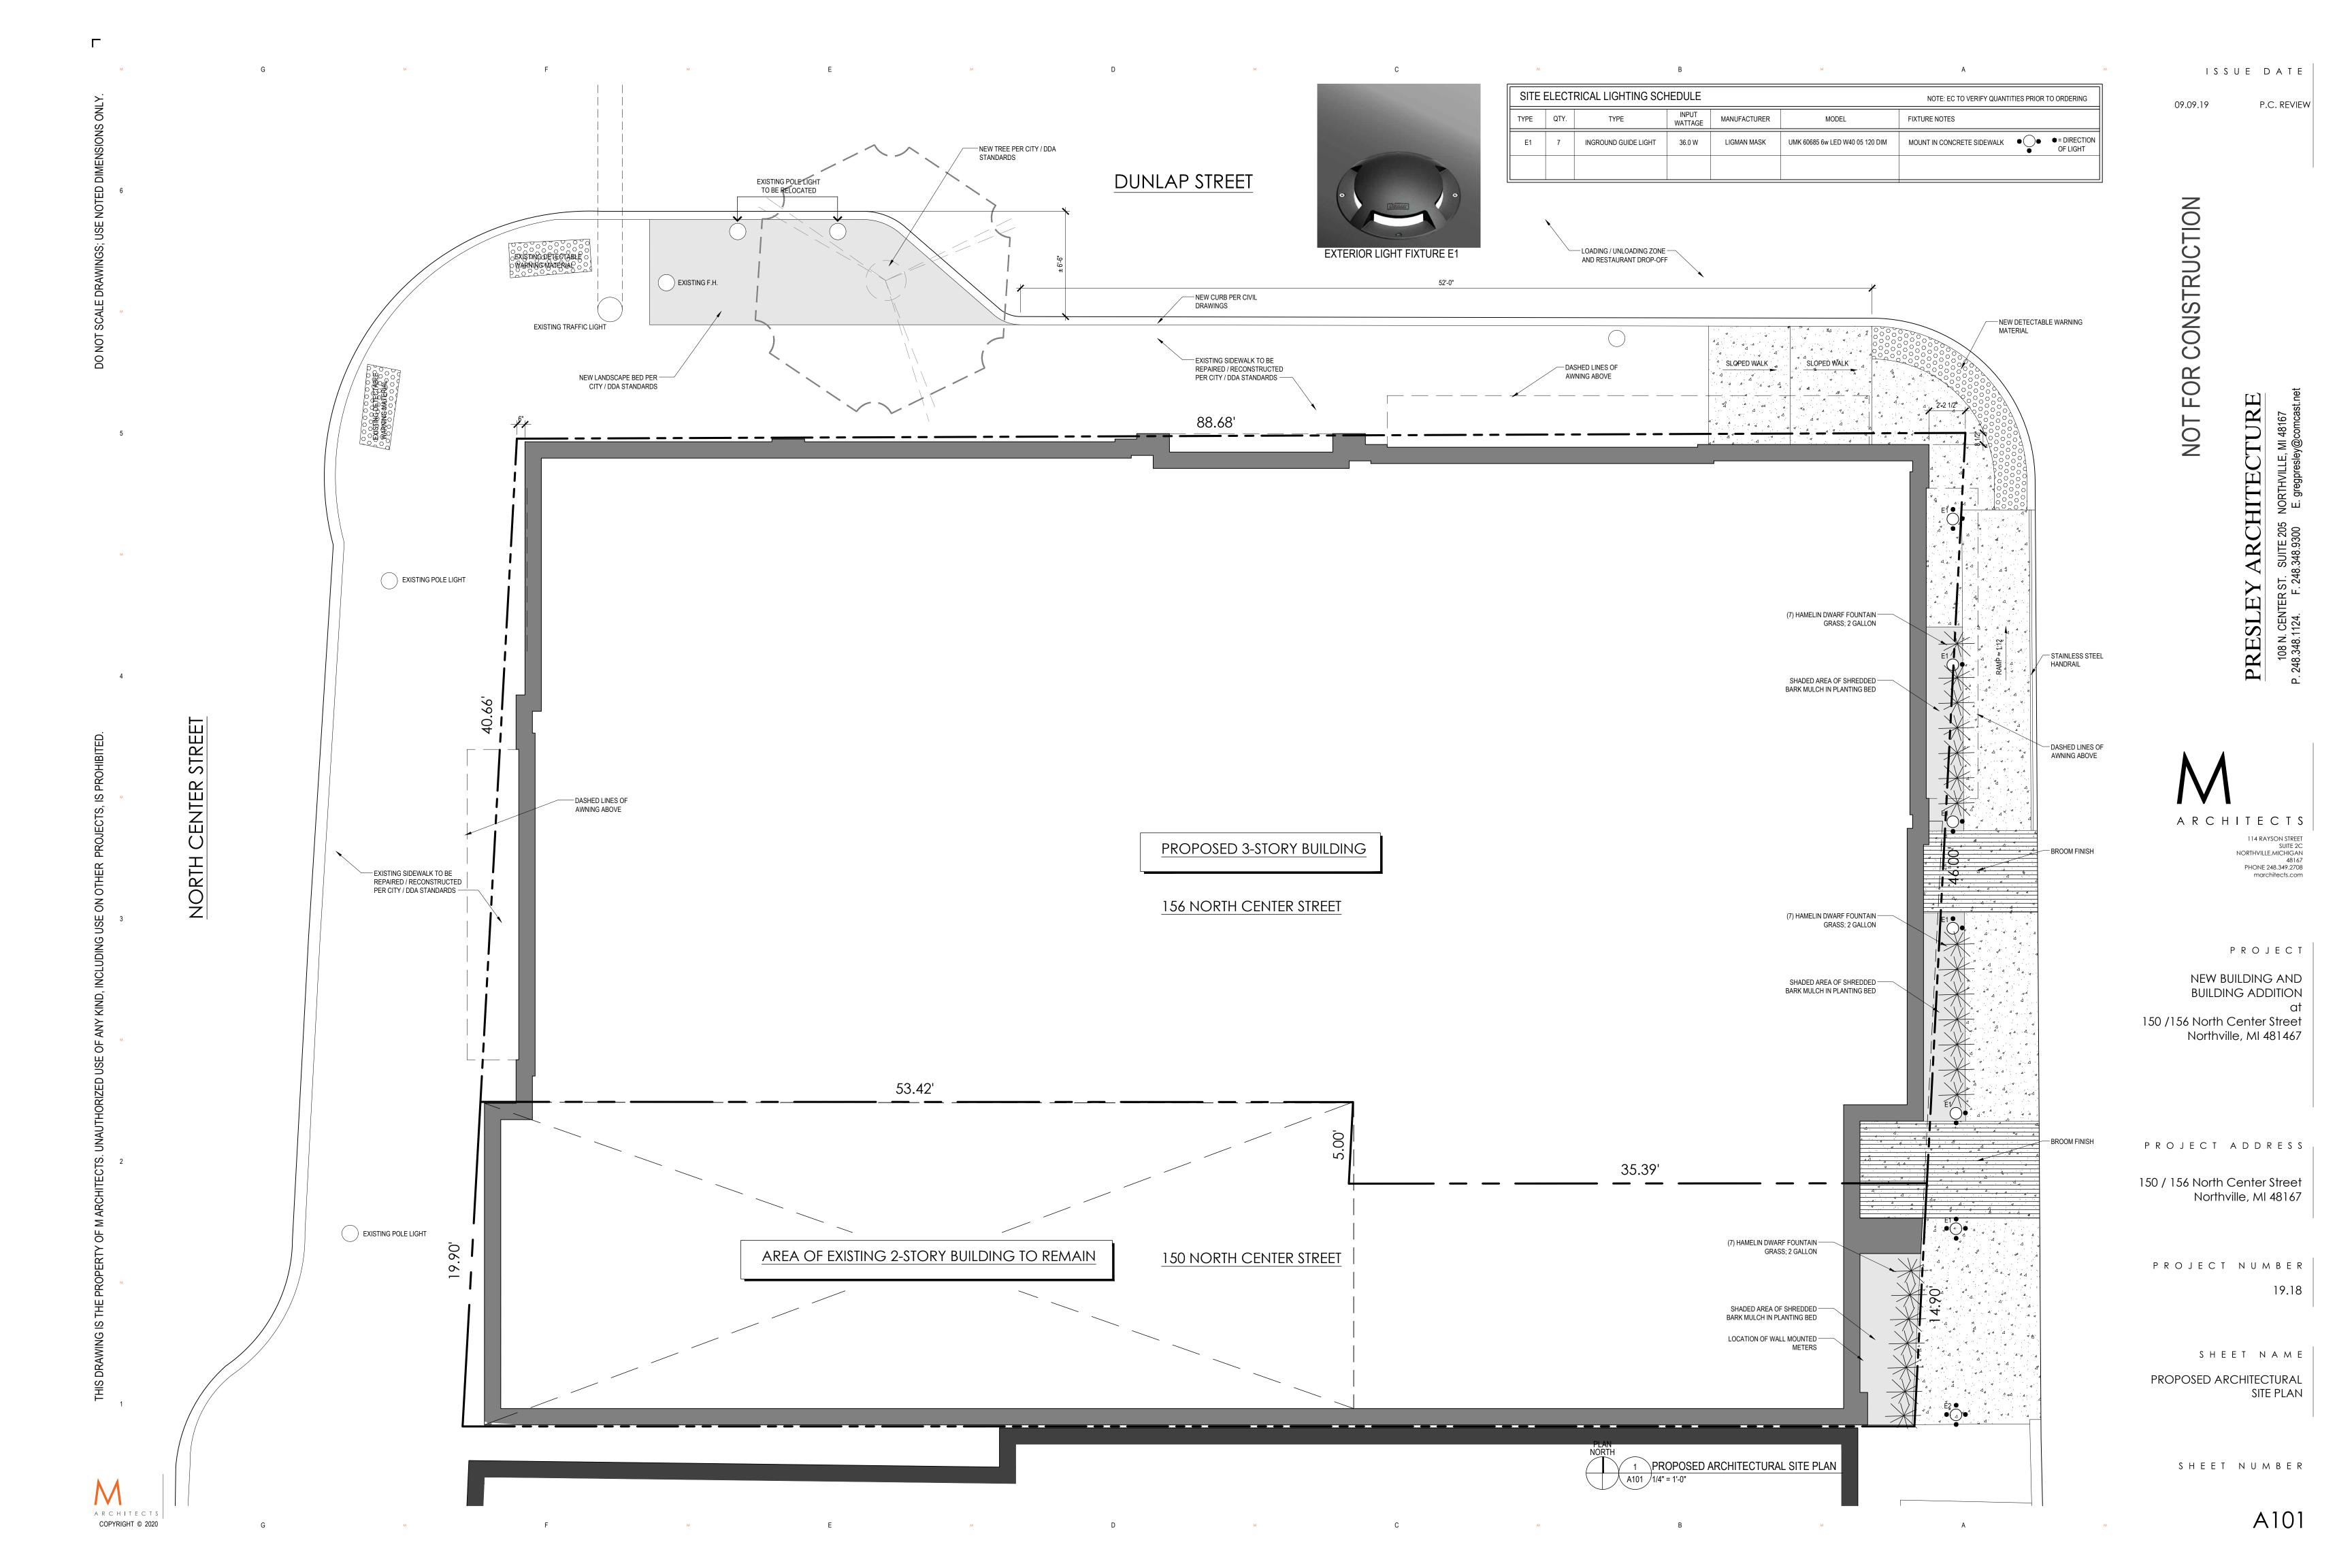

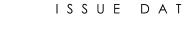



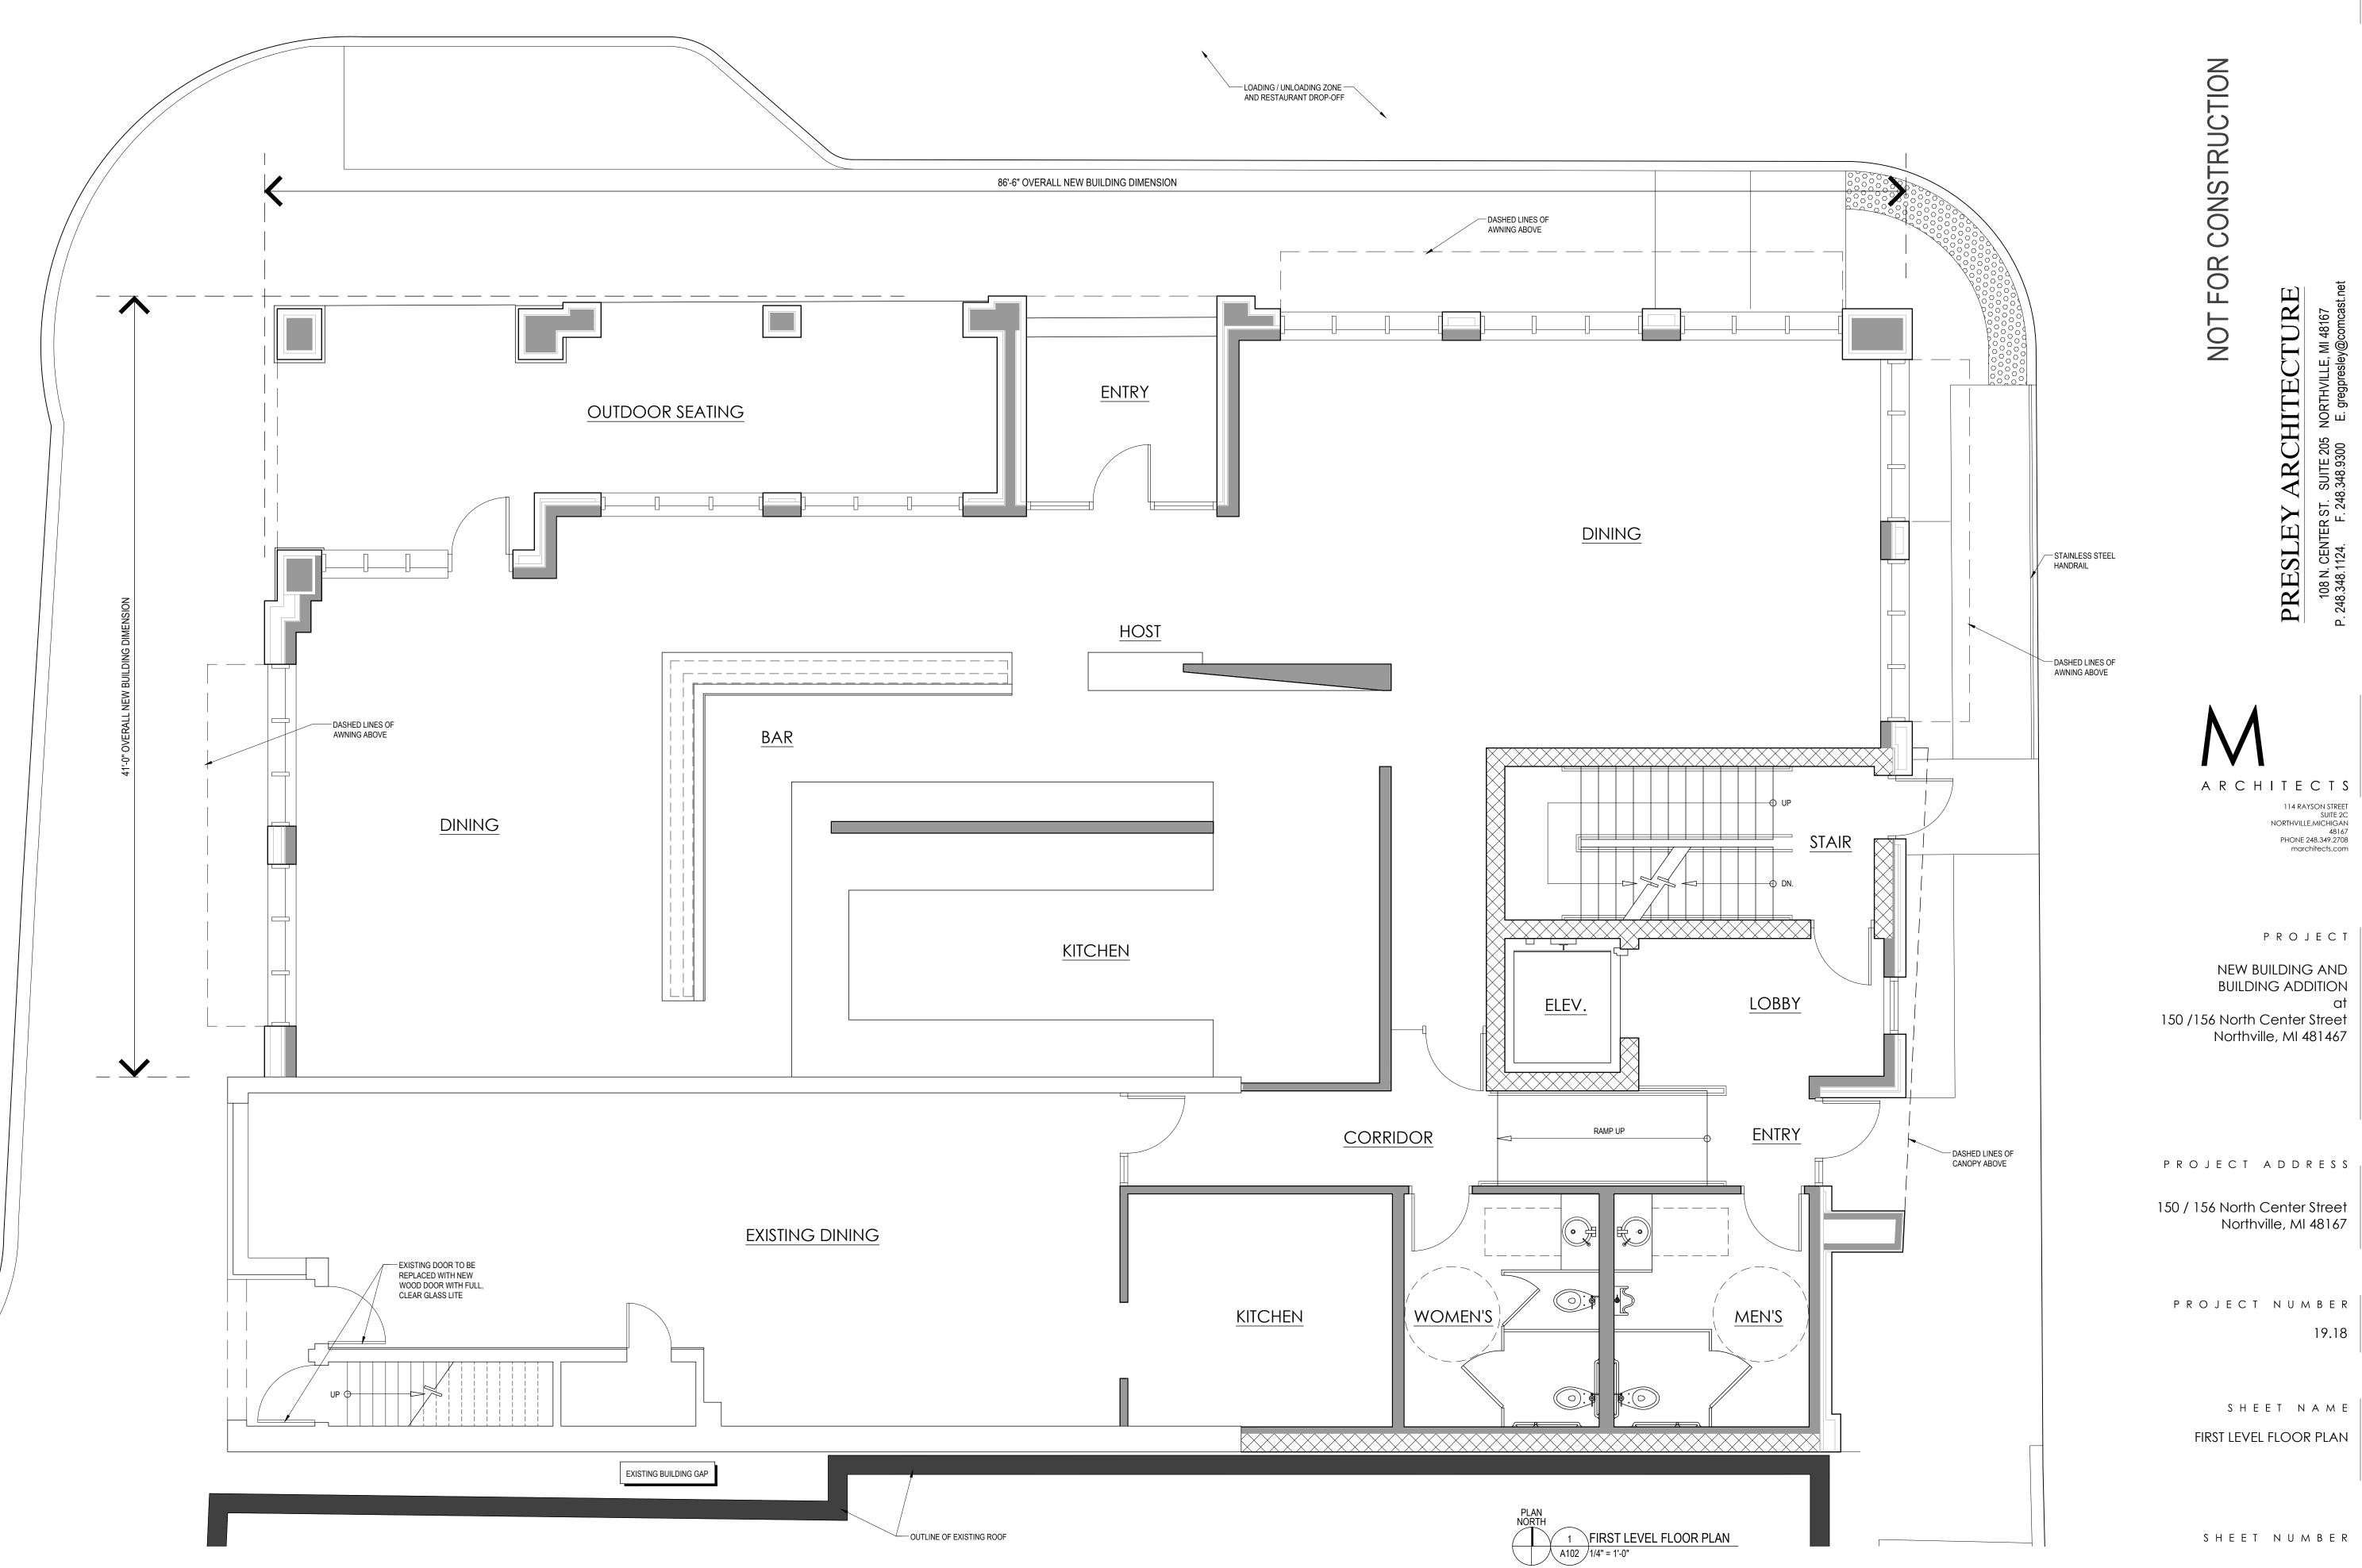

DUNLAP STREET

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A102



PROJECT NUMBER
19.18

SHEET NAME
THIRD LEVEL FLOOR PLAN

SHEET NUMBER





114 RAYSON STREET SUITE 2C NORTHVILLE,MICHIGAN 48167 PHONE 248.349.2708 marchitects.com

PROJECT
NEW BUILDING AND
BUILDING ADDITION

BUILDING ADDITION at 150 /156 North Center Street Northville, MI 481467


PROJECT ADDRESS

150 / 156 North Center Street Northville, MI 48167

PROJECT NUMBER
19.18

SHEET NAME ROOFPLAN

SHEET NUMBER

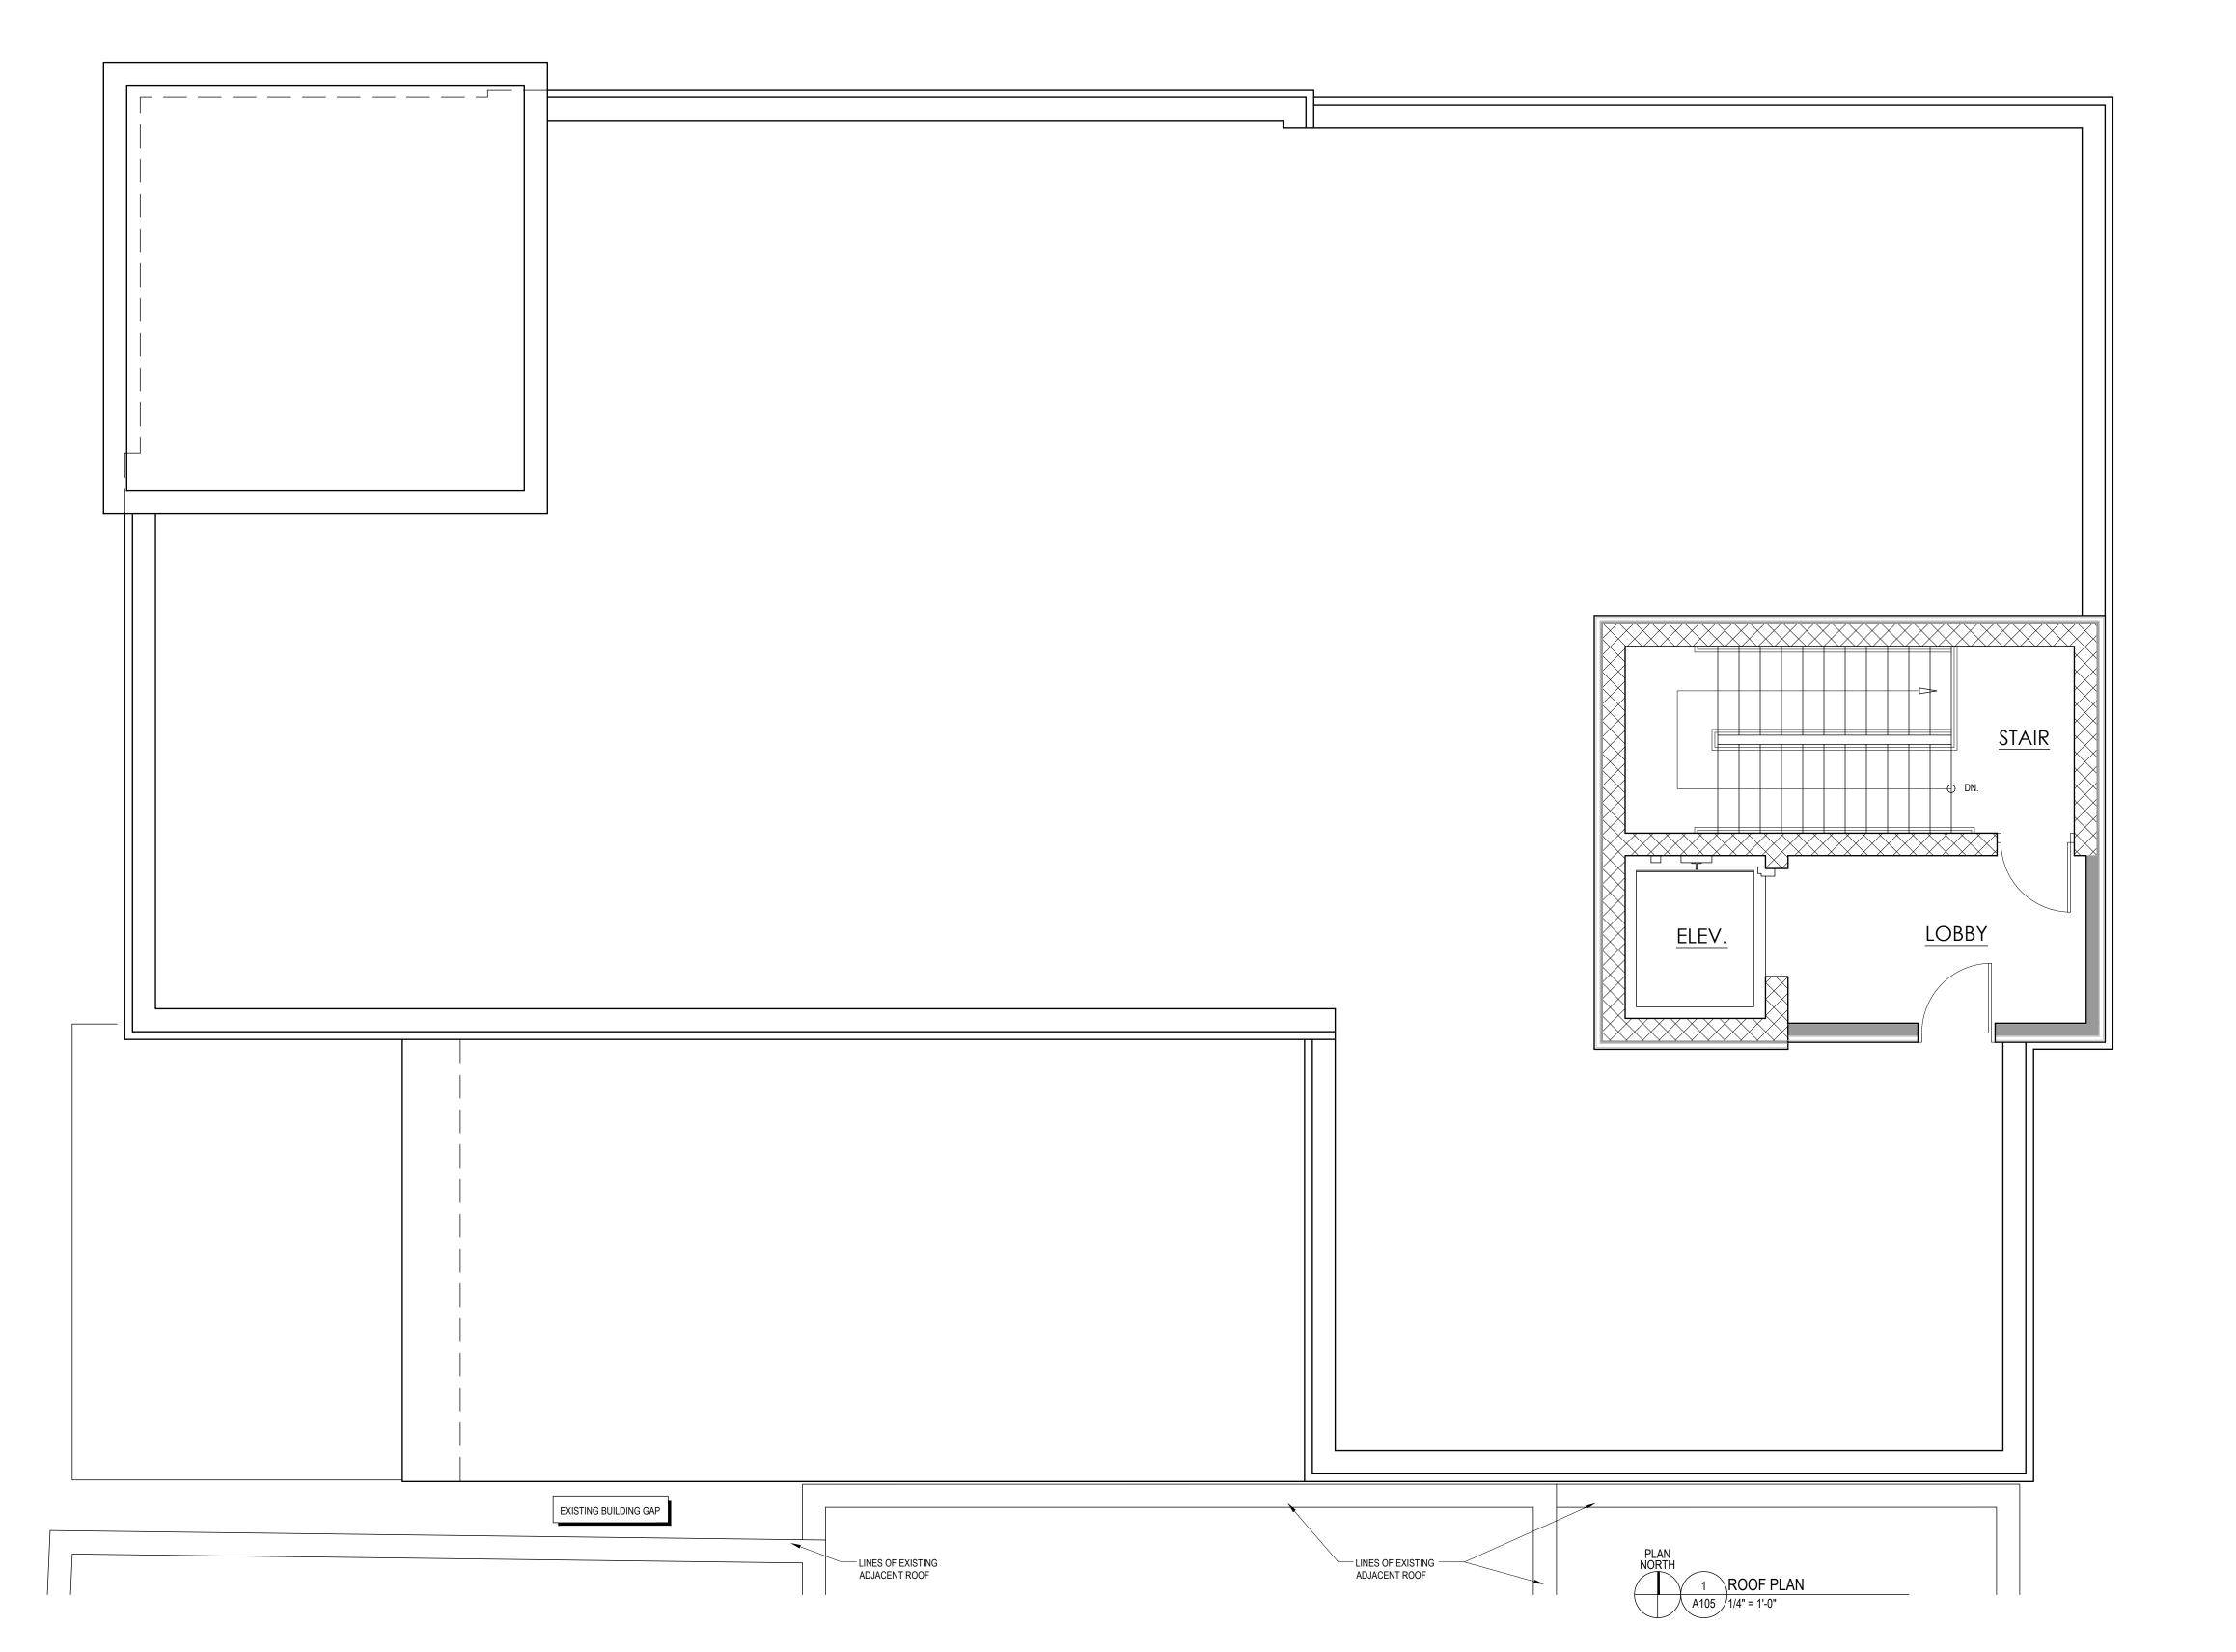

Northville, MI 48167

SHEET NUMBER

1 EXISTING WEST ELEVATION
A301 3/16" = 1'-0"

P.C. REVIEW

09.09.19

NOT FOR CONSTRUCTION

MATERIAL LEGEND
NOT TO SCALE

MATERIAL INFORMATION

1 BRICK 1: GLEN-GERY BRICK TOLEDO GREY S75 MODULAR SOLOMON DEEP BROWN 37X

2 BRICK 2: GLEN-GERY OYSTER GREY SIS56 MODULAR SOLOMON LIGHT BUFF 10X

3 ENGINEERED WOOD 1: SIMILAR TO TRESPA METEON SLATE WOOD NW22/ST

4 ENGINEERED WOOD 2: SIMILAR TO TRESPA METEON HARMONY OAK NW03

5 PAINT 1: SHERWIN WILLIAMS: SW7599 BRICK PAVER

6 PAINT 2: SHERWIN WILLIAMS: SW6105 DIVINE WHITE

7 FABRIC AWNING: MATCH PAINT 1

8 ALUMINUM COPING 1: SIMILAR TO PAC-CLAD: MATTE BLACK


9 ALUMINUM COPING 2: SIMILAR TO SHERWIN WILLIAMS: SW9091 HALF-CAFF

10 WINDOW FRAMES: ANODIZED BLACK

SSLEY ARCHITECTURE

N. CENTER ST. SUITE 205 NORTHVILLE, MI 48167

8 1124 F 248 348 9300 E greatureslev@comcast net

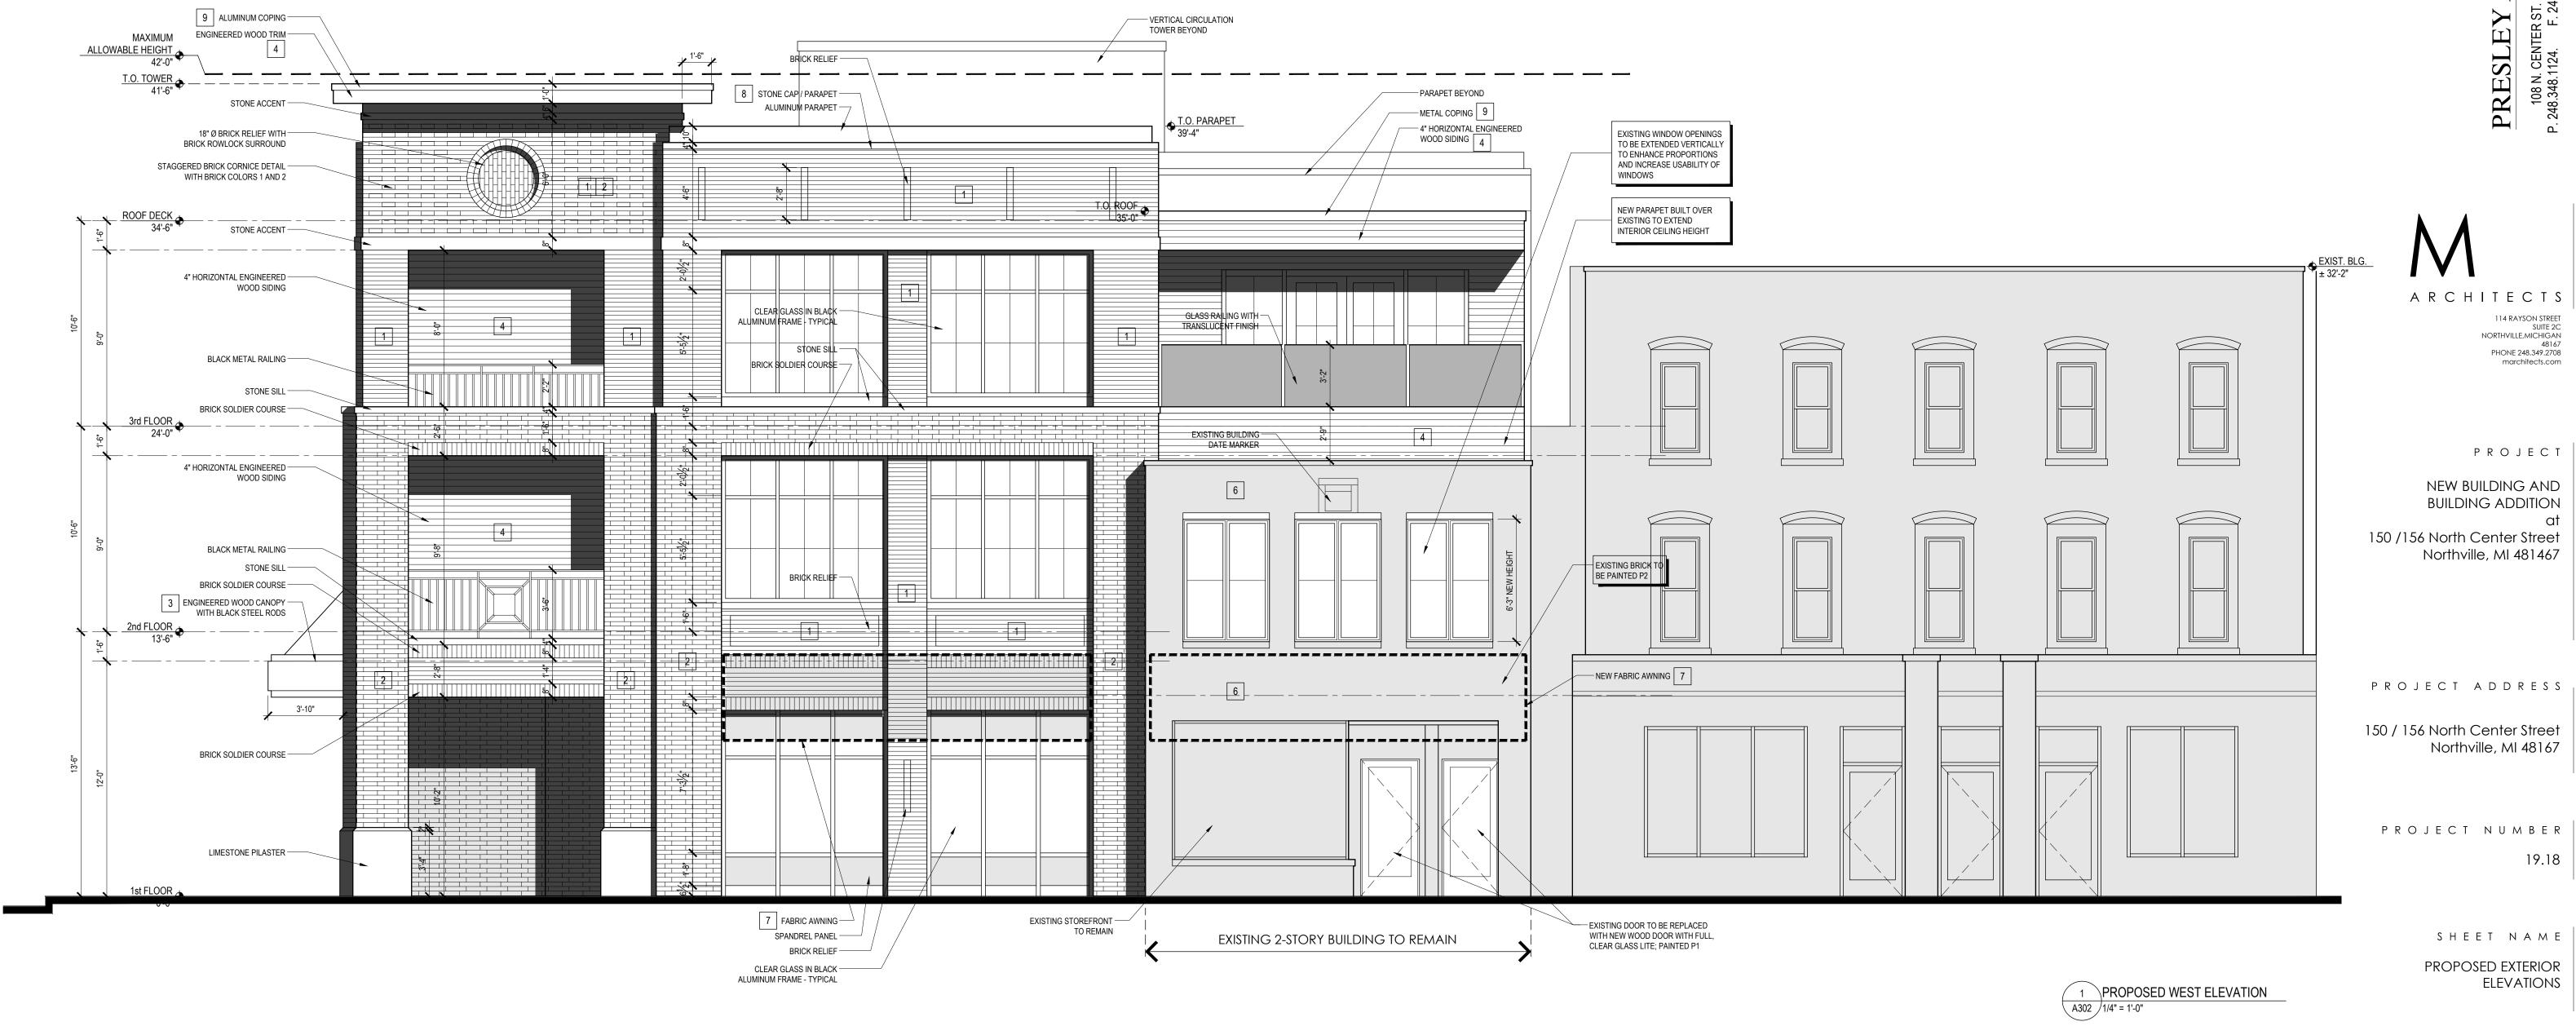

Glen-Gery

SHEET NUMBER

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NOT FOR CONSTRUCTION

ISSUE DATE

Glen-Gery


MATERIAL INFORMATION GLEN-GERY BRICK TOLEDO GREY S75 MODULAR SOLOMON DEEP BROWN 37X 1 BRICK 1: GROUT 1: GLEN-GERY OYSTER GREY SIS56 MODULAR SOLOMON LIGHT BUFF 10X BRICK 2: GROUT 2: BIGINEERED WOOD 1: SIMILAR TO TRESPA METEON SLATE WOOD NW22/ST SIMILAR TO TRESPA METEON HARMONY OAK NW03 4 ENGINEERED WOOD 2: SHERWIN WILLIAMS: SW7599 BRICK PAVER SHERWIN WILLIAMS: SW6105 DIVINE WHITE MATCH PAINT 1 FABRIC AWNING: SIMILAR TO PAC-CLAD: MATTE BLACK SIMILAR TO SHERWIN WILLIAMS: SW9091 HALF-CAFF

ANODIZED BLACK

10 WINDOW FRAMES:

MATERIAL LEGEND

NOT TO SCALE

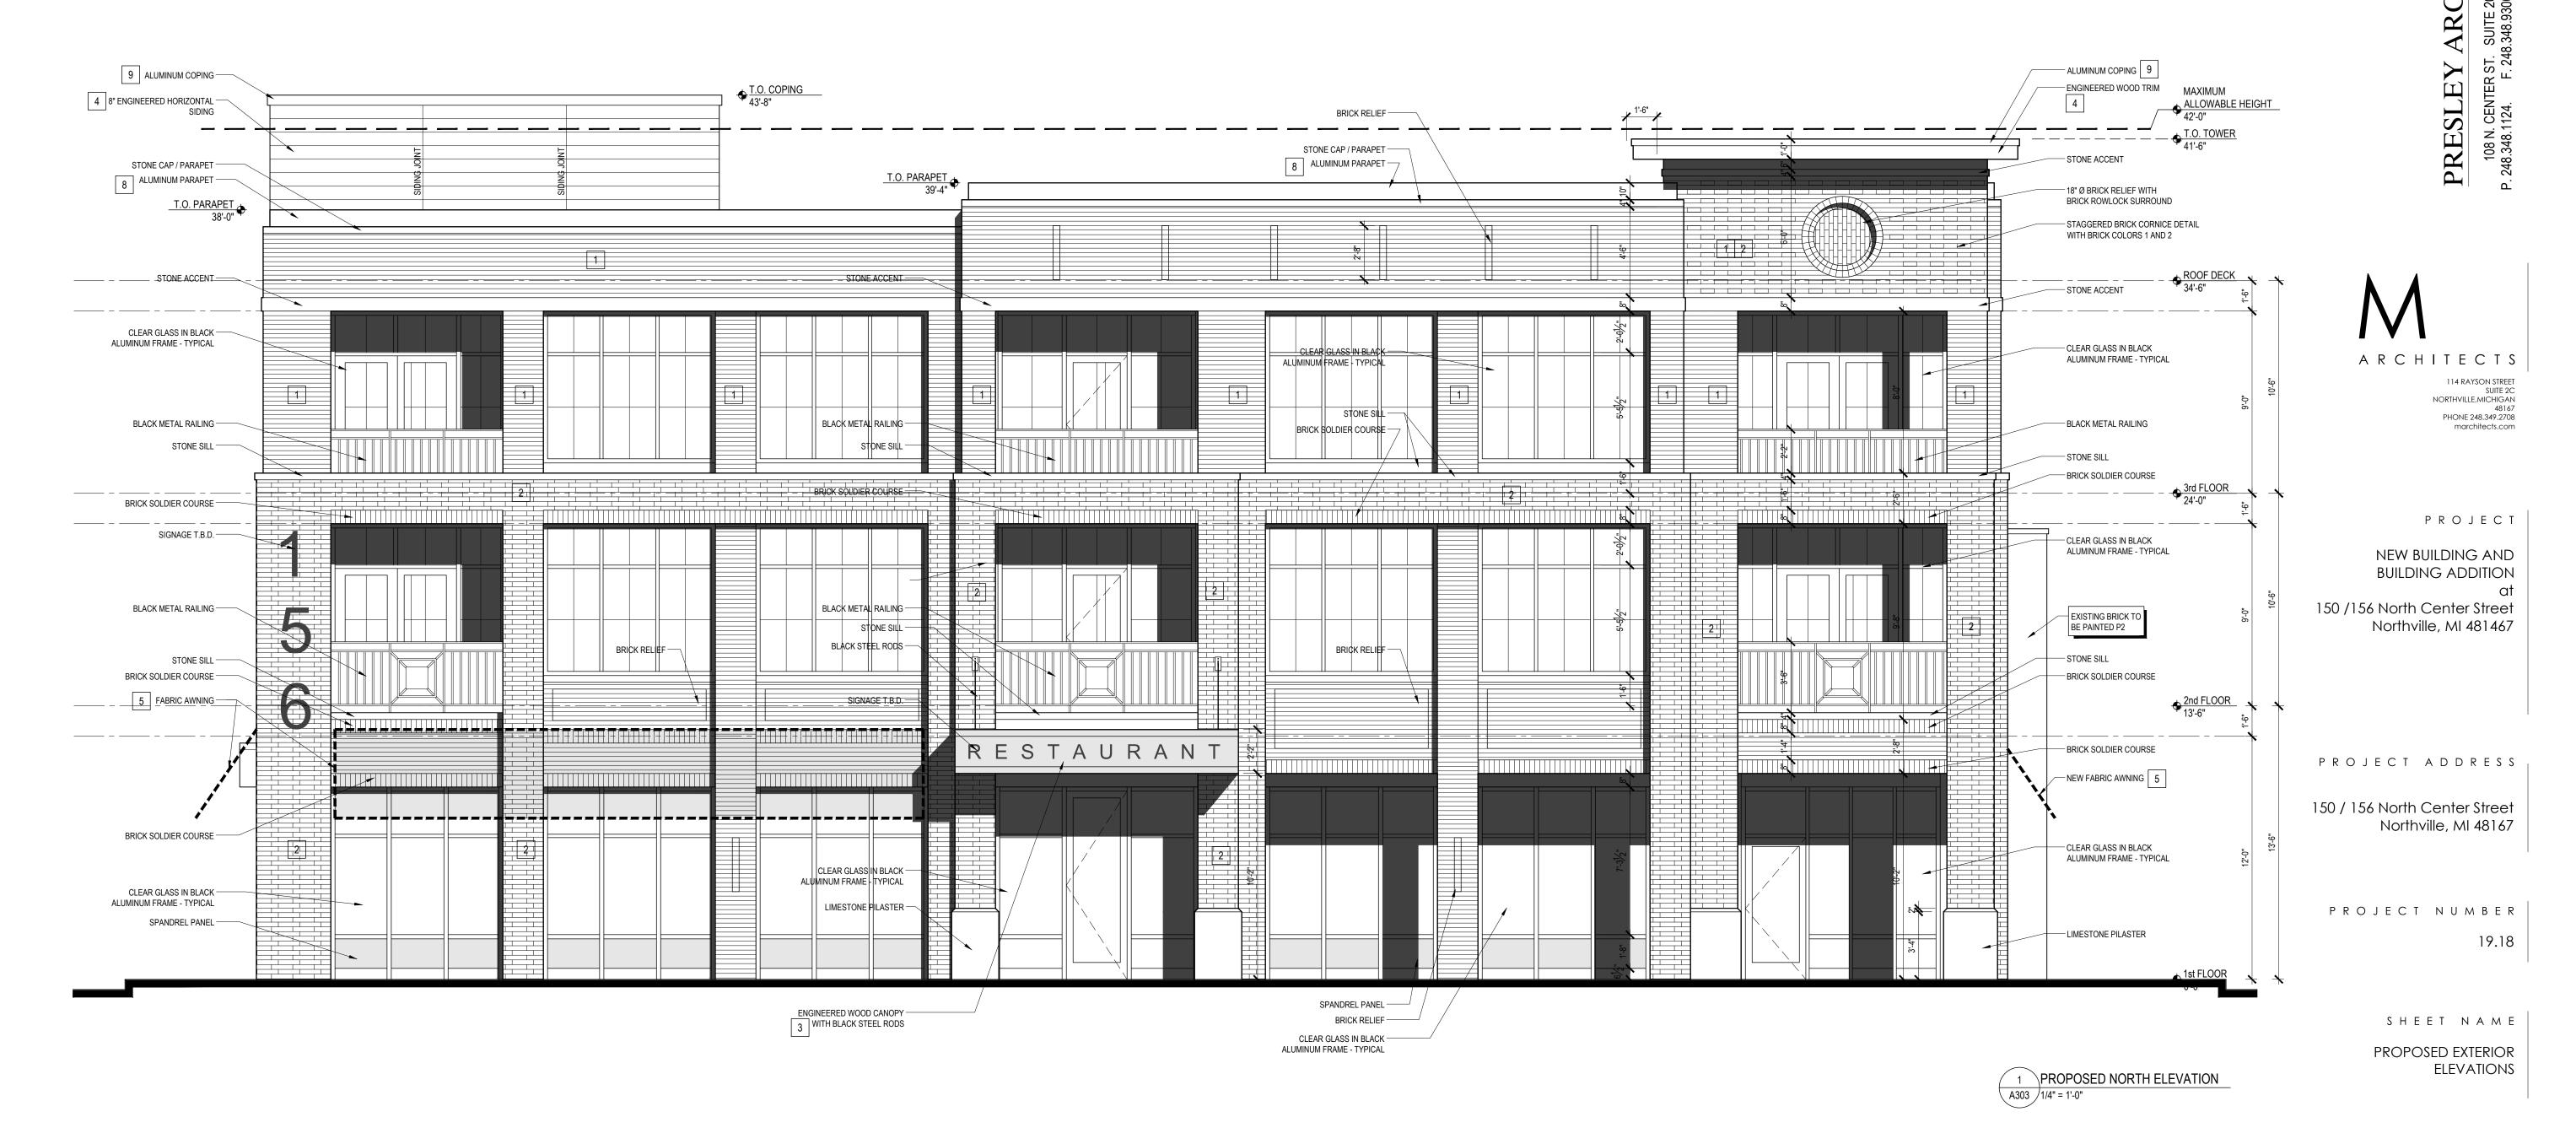

SHEET NUMBER

ISSUE DATE

09.09.19 P.C. REVIEW

NOT FOR CONSTRUCTION

PRESLEY ARCHITECTURE

114 RAYSON STREET SUITE 2C NORTHVILLE,MICHIGAN 48167 PHONE 248.349.2708 marchitects.com

PROJECT NEW BUILDING AND BUILDING ADDITION

Northville, MI 481467

PROJECT ADDRESS

150 / 156 North Center Street Northville, MI 48167

PROJECT NUMBER 19.18

> SHEET NAME PROPOSED EXTERIOR ELEVATIONS

SHEET NUMBER



MATERIAL LEGEND NOT TO SCALE

MATERIAL INFORMATION

GLEN-GERY BRICK TOLEDO GREY S75 MODULAR SOLOMON DEEP BROWN 37X

SIMILAR TO TRESPA METEON HARMONY OAK NW03

SIMILAR TO SHERWIN WILLIAMS: SW9091 HALF-CAFF

GLEN-GERY OYSTER GREY SIS56 MODULAR SOLOMON LIGHT BUFF 10X

SHERWIN WILLIAMS: SW7599 BRICK PAVER SHERWIN WILLIAMS: SW6105 DIVINE WHITE

SIMILAR TO PAC-CLAD: MATTE BLACK

1 PROPOSED EAST ELEVATION
A304 1/4" = 1'-0"

3 ENGINEERED WOOD 1: SIMILAR TO TRESPA METEON SLATE WOOD NW22/ST

MATCH PAINT 1


ANODIZED BLACK

BRICK 1: GROUT 1:

BRICK 2: GROUT 2:

4 ENGINEERED WOOD 2:

10 WINDOW FRAMES:

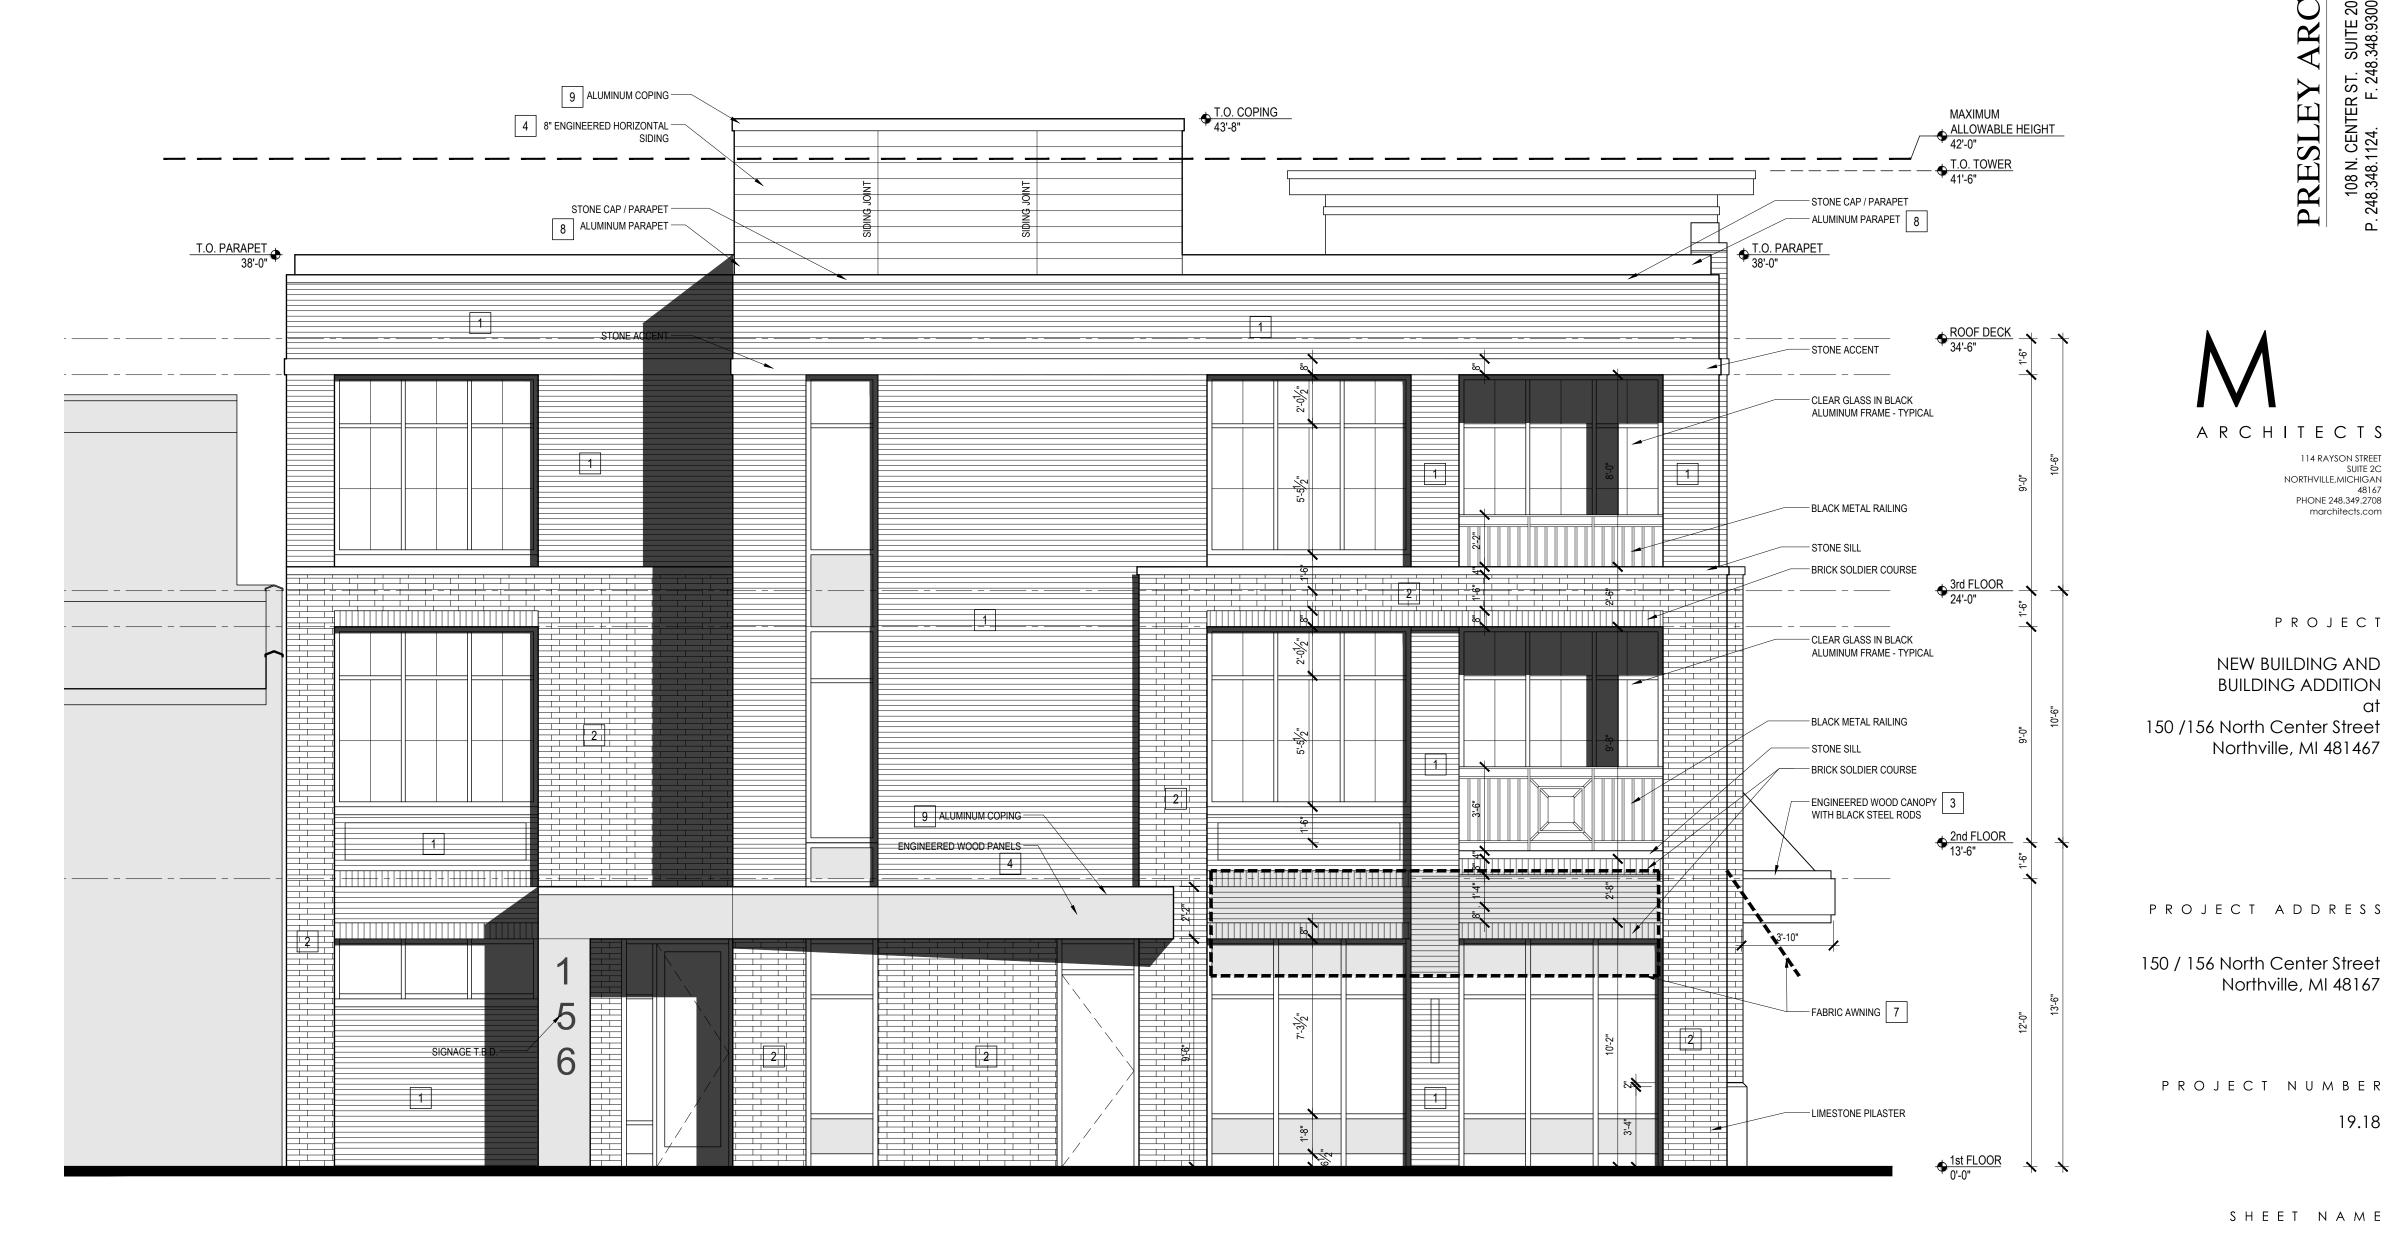

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A304

ISSUE DATE

09.09.19 P.C. REVIEW

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PRESLEY ARCHITECTURE

114 RAYSON STREET SUITE 2C NORTHVILLE,MICHIGAN 48167 PHONE 248.349.2708 marchitects.com

NEW BUILDING AND BUILDING ADDITION 150 /156 North Center Street

PROJECT ADDRESS

150 / 156 North Center Street Northville, MI 48167

19.18

SHEET NAME PROPOSED EXTERIOR ELEVATIONS

SHEET NUMBER



MATERIAL LEGEND NOT TO SCALE

MATERIAL INFORMATION

GLEN-GERY BRICK TOLEDO GREY S75 MODULAR SOLOMON DEEP BROWN 37X

GLEN-GERY OYSTER GREY SIS56 MODULAR SOLOMON LIGHT BUFF 10X

SHERWIN WILLIAMS: SW7599 BRICK PAVER SHERWIN WILLIAMS: SW6105 DIVINE WHITE

3 ENGINEERED WOOD 1: SIMILAR TO TRESPA METEON SLATE WOOD NW22/ST

4 ENGINEERED WOOD 2: SIMILAR TO TRESPA METEON HARMONY OAK NW03

MATCH PAINT 1

9 ALUMINUM COPING 2: SIMILAR TO SHERWIN WILLIAMS: SW9091 HALF-CAFF

ANODIZED BLACK


8 ALUMINUM COPING 1: SIMILAR TO PAC-CLAD: MATTE BLACK

BRICK 1: GROUT 1:

BRICK 2: GROUT 2:

7 FABRIC AWNING:

10 WINDOW FRAMES:

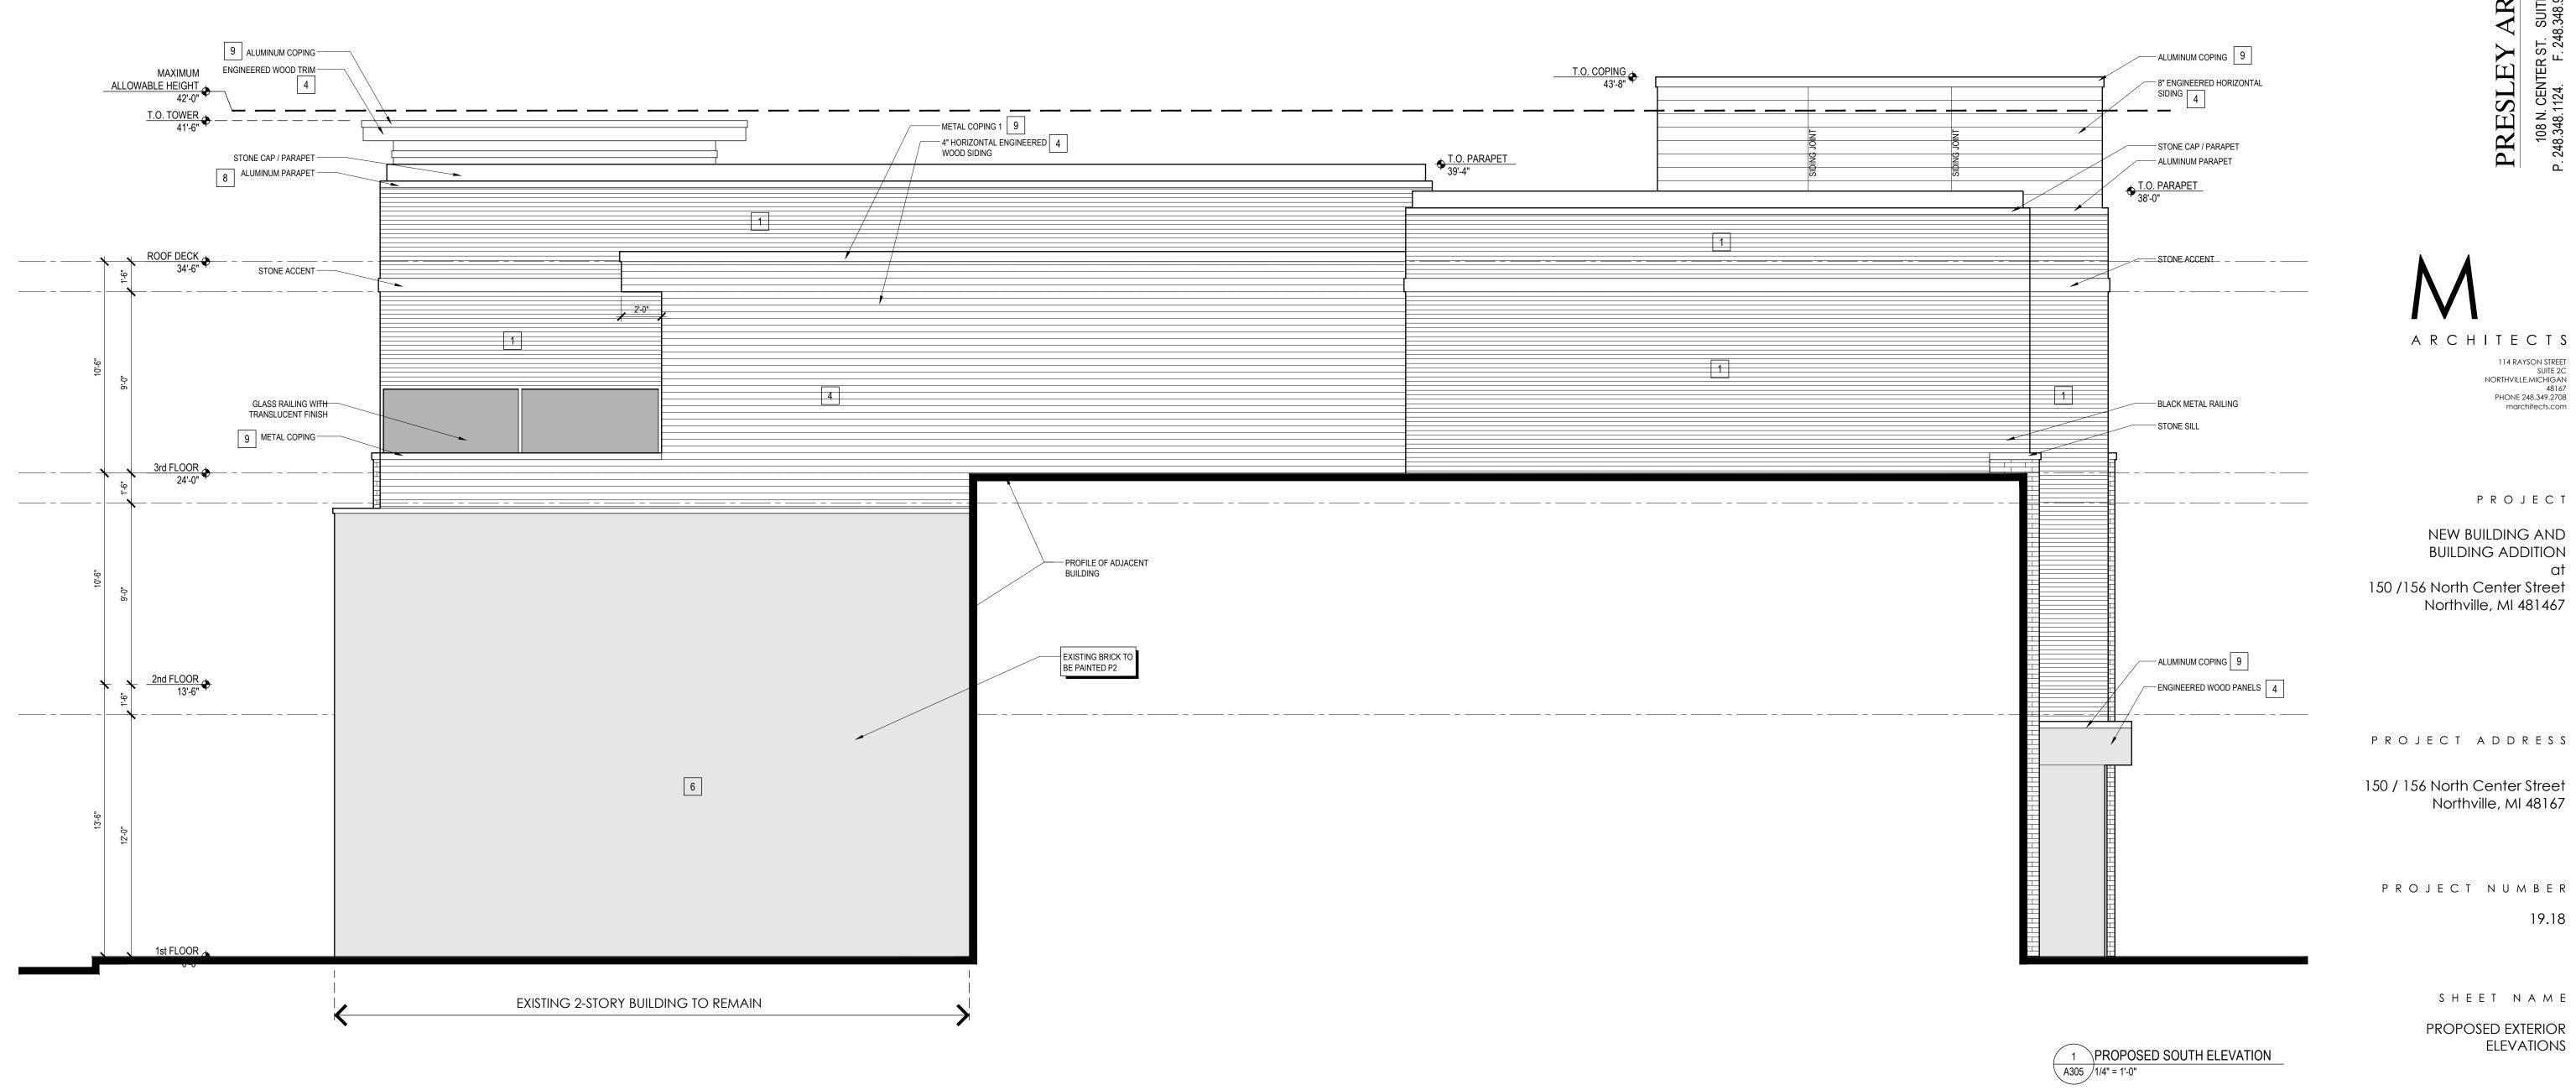

The Michigan Economic Development Corporation's Community Development Department is excited to announce three new resources available to support place-based small businesses. Read more below and discover how each of these new tools can be used to support local businesses within your community that have experienced economic challenges as a result of COVID-19.

Match on Main – COVID-19 Response Program

The Match on Main COVID-19 Response Program temporarily expands the MEDC's Match on Main Program and will provide up to \$50,000 to local downtown management organizations to administer to eligible small businesses located in traditional downtowns, neighborhood and commercial districts, or areas planned and zoned for concentrated commercial development.

This program serves as a tool for local units of government, downtown development authorities, or other downtown management organizations that desire to support place-based businesses located in their traditional commercial districts by providing grant funding to eligible businesses in response to the COVID-19 crisis.

The local unit of government, downtown development authority, Main Street organization or other economic development organization that represents the downtown is eligible to apply for up to \$50,000. The minimum contribution that is able to be administered to any one business must be at least \$2,000, with a maximum of \$10,000. The applicant will determine which businesses are selected for inclusion in the application for support and at what desired grant amounts.

The application window is May 13, 2020 through May 29, 2020. All applications will be due by 5 p.m. on Wednesday, May 29.

Learn more about the program here: https://www.miplace.org/match-on-main

MI Local Biz – Crowdfunding Model for Small Businesses

In response to the COVID-19 crisis, MEDC, in conjunction with the Detroit-based crowdfunding platform Patronicity, has developed "MI Local Biz," a creative funding mechanism that offers quick access to capital for small local businesses during this unprecedented time of need. The MEDC will match crowdfunding raises on a 1:1 basis up to \$5,000 for eligible small businesses experiencing economic challenges as a result of COVID-19 such as restaurants, bars, coffee shops, salons, hardware stores, retail shops, etc.

Modeled after the MEDC's highly successful Public Spaces Community Places program, MI Local Biz is a matching grant program that utilizes donation-based crowdfunding to generate public interest, raise funds to assist small businesses negatively affected by the COVID-19 crisis, and help position that business for re-opening as the crisis eases. By utilizing web-based donations, businesses are accessible to anyone willing to donate in real time. This crowd granting model engages the public as each person contributes in the effort to assist their local businesses. Also, this model instills community pride as residents become a conduit of support for their local economy.

Applications will be accepted through the Patronicity platform starting May 18, 2020 at 8 a.m. Business applications will be evaluated on a first come, first served basis. Limited funding is available.

Learn more about the program here: https://www.patronicity.com/milocalbiz

Michigan Reopen Main Street Recovery Resources

Main Streets across Michigan are currently operating in a new reality due to the impact of COVID-19. As a way to help Main Street directors, downtown development authority managers, small business owners and local stakeholders navigate the complexities of re-opening their local business districts - the MEDC has partnered with Reopen Main Street to compile a variety of recovery resources into one, easy-to-use website. The new website includes reopening strategies, ideas, hints and tips for businesses, business districts and organizations. View Michigan's Reopen Main Street website here: https://michigan.reopenmainstreet.com/

Additional Resources Available Online

- Access additional resources by visiting <u>michiganbusiness.org/covid19</u>.
- Visit <u>michigan.gov/coronavirus</u> to find valuable resources for employers, workers, residents and communities and stay informed on Michigan's latest efforts to mitigate the impact of the virus on our state's residents and economy.
- Information around this outbreak is changing rapidly. The latest information is available at https://www.michigan.gov/coronavirus and https://www.cdc.gov/coronavirus.